


#### Rendering of Proposed Exterior

NOTE: THIS RENDERING IS FOR ILLUSTRATIVE PURPOSES ONLY. NOT TO BE USED FOR DESIGN, PERMITTING, BIDDING, OR CONSTRUCTION.

# **Project Team**

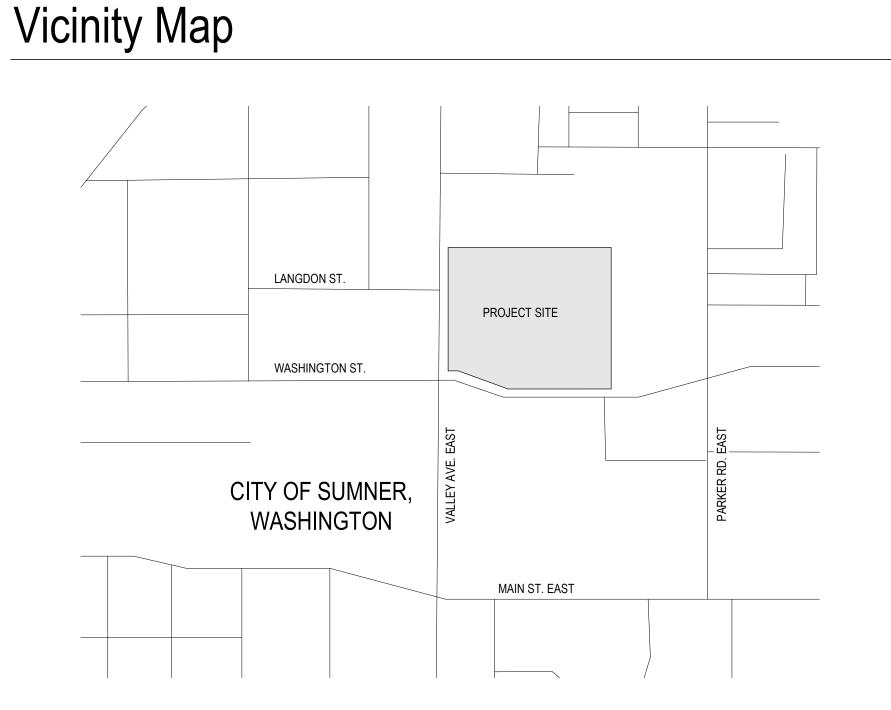

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## Drawing Index

LANDSCAPE PLAN (NORTH) LANDSCAPE PLAN (SOUTH)

LANDSCAPE DETAILS AND NOTES

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ENLARGED PLANS AND INTERIOR ELEVATIONS

WINDOW AND DOOR TYPES AND SCHEDULES

ROOM FINISH PLAN AND SCHEDULE

ARCHITECTURAL

SITE PLAN SITE DETAILS

WALL SECTIONS EXTERIOR DETAILS

INTERIOR ELEVATIONS INTERIOR ELEVATIONS

<u>GENERAL</u>		KITCHE	KITCHEN (FOR REFERENCE ONLY)		MECHANICAL	
G001 G002	COVER SHEET PROJECT AND CODE INFORMATION	K1 STREET	FOODSERVICE EQUIPMENT PLAN  LIGHTING (FOR REFERENCE ONLY)	M001 M002 M003	MECHANICAL LEGEND & NOTES MECHANICAL NOTES MECHANICAL SCHEDULES	
CIVIL C1 C2 C3 C4 C5 C6	COVER SHEET EXISTING CONDITIONS TEMPORARY EROSION & SEDIMENTATION CONTROL PLAN (TESC OVERVIEW) TEMPORARY EROSION & SEDIMENTATION CONTROL PLAN TESC DETAILS AND NOTES STORMWATER POLLUTION PREVENTION PLAN (SWPPP)	PSE1 PSE2 STRUC' S001 S002	GENERAL NOTES GENERAL NOTES	M201 M301 M302 M303 M401 M402 M403 M404	FOUNDATION PLAN PLUMBING PLAN PLUMBING DETAILS PLUMBING DETAILS HVAC PLAN ROOF PLAN MECHANICAL DETAILS MECHANICAL DETAILS	
C7 C8 C9 C10 C11 C12 C13 C14 C15	SITE PLAN (OVERVIEW) DRAINAGE PLAN GRADING PLAN - NORTH GRADING PLAN - SOUTH SEWER, WATER, & FIRE PLAN PAVING DETAILS AND ROADWAY NOTES PAVING AND DRAINAGE DETAILS DRAINAGE DETAILS AND STORMWATER PLAN NOTES STORMWATER DETENTION POND SECTION AND FLOW CONTROL DETAILS STORMWATER DETENTION POND AND TREATMENT DETAILS SANITARY SEWER DETAILS AND SEWER SYSTEM NOTES WATER AND FIRE PROTECTION DETAILS AND WATER SYSTEM NOTES	S003 GENERAL NOTES S004 GENERAL NOTES S101 FOUNDATION PLAN S102 ROOF FRAMING PLAN S201 FOUNDATION DETAILS S301 FRAMING DETAILS S302 FRAMING DETAILS S303 FRAMING DETAILS S304 FRAMING DETAILS	ELECT E001 E101 E201 E301 E401 E501 E502 E601 E602	RICAL  LEGEND, ABBREVIATIONS, AND NOTES ELECTRICAL SITE PLAN LIGHTING PLAN POWER AND LOW VOLTAGE ROUGH-IN PLAFIRE ALARM PLAN ELECTRICAL ONE-LINE DIAGRAM ELECTRICAL SCHEDULES ELECTRICAL DETAILS ELECTRICAL DETAILS		
C19	FIRE PROTECTION DETAILS					

# **Project Information**

PROJECT DATA	
PROJECT NAME:	ST. ANDREW CATHOLIC CHURCH PARISH HALL
PROJECT DESCRIPTION:	NEW, SINGLE STORY PARISH HALL, STRUCTURE, AND ASSOCIATED SITE WORK
OWNER:	CORPORATION OF THE CATHOLIC ARCHBISHOP OF SEATTLE 710 9TH AVENUE, SEATTLE, WA 98104, 206-382-4851
SITE ADDRESS:	1401 VALLEY AVE. E. SUMNER, WA 98390-2720
PARCEL NUMBER:	0520192161
LEGAL DESCRIPTION:	PARCEL A OF CITY OF SUMNER LOT LINE ADJUSTMENT RECORDED FEBRUARY 9, 1999 UNDER RECORDII NUMBER 9902095001. RECORDS OF PIERCE COUNTY, WASHINGTON; EXCEPT THE SOUTH 110.00 FEET OF EAST 55.00 FEET THEREOF.  (BEING KNOWN AS REVISED PARCEL A OF CITY OF SUMNER BOUNDARY LINE ADJUSTMENT NO. PLN-2001-00-0037. RECORDED UNDER RECORDING NUMBER 200106200171.)  SITUATED IN THE COUNTY OF PIERCE. STATE OF WASHINGTON.
LOT AREA:	11.48 ACRES OR 500,072 SF
ZONING:	CITY OF SUMNER, WA: • LOW RISE RESIDENTIAL 8500 (LDR 8.5) • INTENDED USE IS 'CONDITIONALLY PERMITTED' USE PER 18.12.40
ZONING ALLOWABLE HEIGHT:	50 FEET PER SMC 18.12.080-L CHURCHES ALLOWED TO BE 50; (TYP. ZONING LIMIT 30') ✓ OK
PARKING:	EXISTING: 117 STANDARD + 9 ADA STALLS (126 TOTAL EXISTING) PROPOSED NEW: 59 STANDARD + 4 ADA STALLS (63 TOTAL NEW) 189 TOTAL STALLS ON SITE

2019 - SITE DEVELOPMENT PERMIT SIT - 2019 - 0039 DEFERRED PERMIT SUBMITTALS: 2019 - FIRE PROTECTION PERMITS

2019 - SEPA PERMIT

2019 - CONDITIONAL USE PERMIT

2019 - NPDES

2019 - VARIANCE

#### **BUILDING CODE REQUIREMENTS**

RELATED PERMITS:

AREA:	9.404 SF PROPOSED	, 24,500 ALLOWED, ✓ OK	
CONSTRUCTION TYPE:	VB		
OCCUPANCY:	A3, B OCCUPANCY @ KITCHEN 1 HOUR WALL SEPARATION BETWEEN KITCHEN AND A3 OCCUPANCIES		
OCCUPANT LOAD:	HALL: MEETING ROOMS: KITCHEN:	282 75 3	
	TOTAL:	382 PERSONS	
SPRINKLERS:	NEW NFPA (13) WET	TYPE AND ASSOCIATED FIRE A	LARM SYSTEM
FIRE RESISTANCE RATING: (TABLE 601)	TYPE VB PRIMARY STRUCTURAL FRAME 0 HOURS BEARING WALLS (INTERIOR AND EXTERIOR) 0 HOURS NON-BEARING EXTERIOR WALLS TABLE 602 NON-BEARING INTERIOR WALLS 0 HOURS FLOOR CONSTRUCTION / SECONDARY MEMBERS 0 HOURS		0 HOURS TABLE 602 0 HOURS

APPLICABLE CODES: INTERNATIONAL BUILDING CODE (IBC), 2015 EDITION - CHAPTER 51-50 WAC INTERNATIONAL MECHANICAL CODE (IMC), 2015 EDITION - CHAPTER 51-52 WAC INTERNATIONAL FUEL GAS CODE (IFGC), 2015 EDITION - CHAPTER 51-52 WAC INTERNATIONAL FIRE CODE (IFC), 2015 EDITION - CHAPTER 51-54 WAC UNIFORM PLUMBING CODE (UPC), 2015 EDITION - CHAPTER 51-56, 51-57 WAC

WASHINGTON STATE ENERGY CODE (WSEC), 2015 EDITION - USE ENV-UA & ENV-SHGC PATH - C406.1.2 REDUCED LIGHTING POWER

- C406.1.7 ENHANCED ENVELOPE PERFORMANCE INTERNATIONAL ENERGY CONSERVATION CODE (IECC) - CHAPTER 51-11C & 51-11R WAC

PLN - 2019 - 0017

PLN - 2019 - 0016

PLN - 2019 - 0107

1 STORY, 35'-8" PROPOSED, 2 STORIES, 50' ALLOWED PER ZONING, ✓ OK

N.O.I # 21414

W.A.R. # XXXX

\*NOTE: ALL CODES ARE SUBSEQUENTLY MODIFIED BY WASHINGTON ADMINISTRATIVE CODE (WAC) **AMENDMENTS** 

ROOF CONSTRUCTION / SECONDARY MEMBERS 0 HOURS

DESIGN CRITERIA: SEISMIC DESIGN: SITE CLASS D-1 PER ASCE / SEI 7-10 AT ULTIMATE FORCE LEVEL - 85 MPH WIND SPEED: **EXPOSURE B\*** 

SNOW LOAD: 25 LBS / SF - GROUND 2" / HOUR FOR ROOF DRAINAGE RAIN: SOILS: PER IBC SECTION 1804

SOILD CLASSIFICATION TYPE: PER SITE PSECIFIC GEOTECH REPORT BY GEOENGINEERS

\*UNLESS A GREATED VALUE IS REQUIRED UNDER SITE SPECIFIC CONDITIONS

BRADLEY P. CORNWELL STATE OF WASHINGTON


hdiocese of Seattle

Andrew Catholic Church

Valley Avenue East

Job No: 1851 Date: 2020-02-07 File No: 1851 St. Andrew Parish Hall Drawn By: AMR Checked By: BPC Issued for: PERMIT SET **COVER SHEET** 

## Architectural Symbols

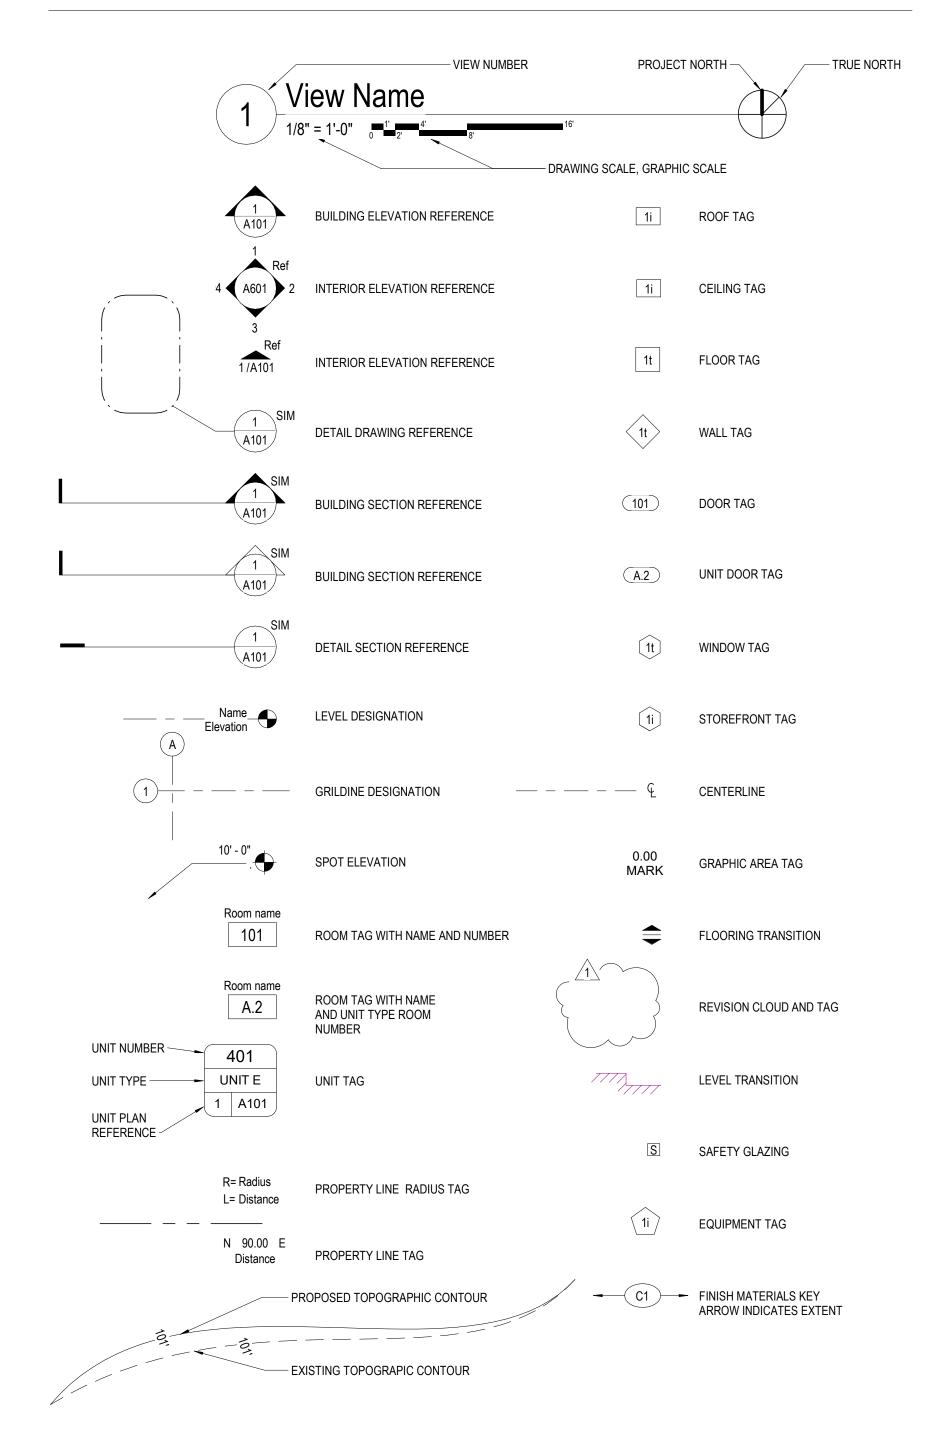

### Fire Department Additional Information

DISTRICT FIRE DEPARTMENT PERMIT CHECKLIST		
UNDERGROUND FIRE SERVICE MAIN		
FIRE SPRINKLERS		
FIRE ALARM SYSTEM		
FIRE STAND PIPE	N/A	
FIRE APPARATUS ACCESS ROAD	N/A	

#### KITCHEN STORAGE STOR В 587 587 200 300 ONE HOUR WALL SEPARATION — STORAGE STOR 204 300 \_\_\_\_\_\_121'-11" = TRAVEL DISTANCE MEETING ROOMS HALL A3 A3 732 4326 15 15 49 282 MEETING ROOMS A3 357 15 24

#### **WSEC CALCULATIONS**

• TOTAL WALL AREA: 7,660 SF • TOTAL FENESTRATION: 951 SF

PERCENT OF OPENINGS: 7.5%
MAX. AREA OF OPENINGS ALLOWED: 30.0% ✓ OK

BUILDING SHALL PERFORM TO WSEC C103.2 AND C402.5.1.2 BUILDING AIR LEAKAGE TEST IN ACCORDANCE WITH ASTM E779 OR EQUIVALENT. MAX LEAKAGE RATE = 0.40 CFM/SQFT @ PRESSURE

DIFFERENTIAL OF 0.3" WATER GAUGE.

• AIR ENVELOPE AREAS ARE:

AIR ENVELOPE AREAS AREA


1. SUBMIT AIR BARRIER TEST RESULTS TO ARCHDIOCESE OF SEATTLE AND AHJ. 2. IF TEST RESULTS EXCEED 0.40 CFM/FT<sup>2</sup> THEN VISUALLY INSPECT AIR BARRIER

AND SEAL NOTED SOURCES OF LEAKAGE.

3. SUBMIT FOLLOW-UP REPORT TO ARCHDIOCESE AND AHJ NOTING CORRECTIVE MEASURES TAKEN.

MEASURES TAKEN.
4. INCLUDE TEST REPORT IN CLOSEOUT DOCUMENTATION.

#### Plan Legend

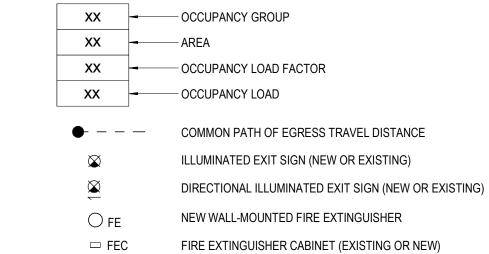

1 Life Safety Plan (SPRINKLERED STRUCTURE)

1/16" = 1'-0"

A R C H I T E C T S

BRADLEY P. CORNWELLY STATE OF WASHINGTON

Archdiocese of Seattle

St. Andrew Catholic Church Parish H

1401 Valley Avenue East

PROJECT AND CODE

 Job No:
 1851
 Date: 2020-02-07

 File No:
 1851 St. Andrew Parish Hall

Drawn By: AMR
Checked By: BPC

Issued for: PERMIT SET

G002

INFORMATION