
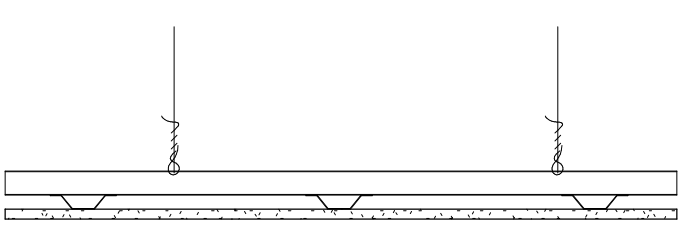
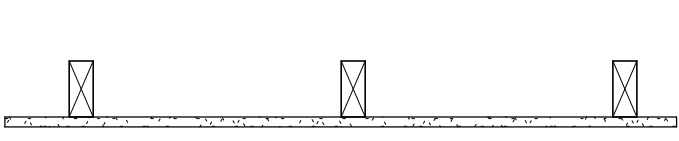
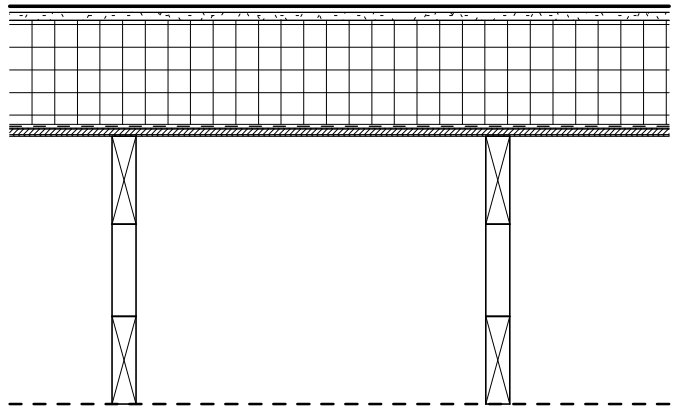
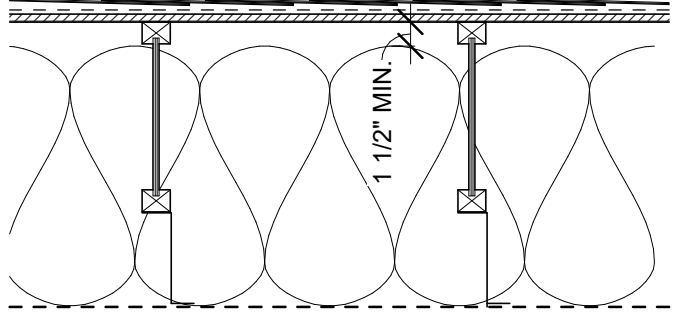
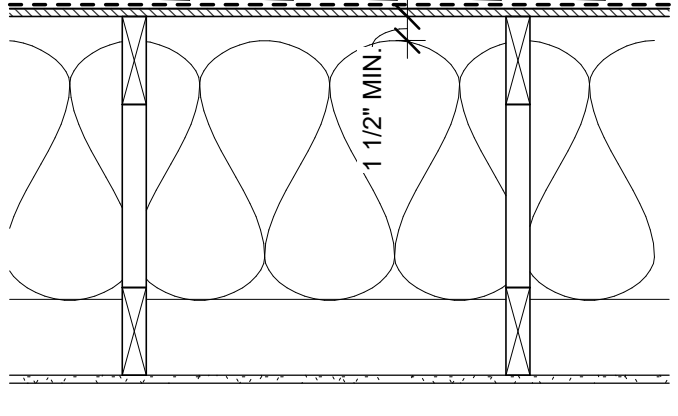
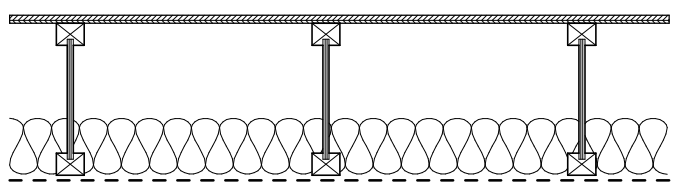
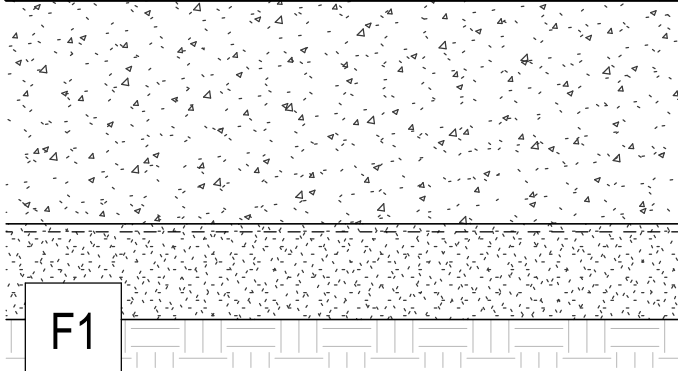
 <p>C2</p>	<p>CEILING ASSEMBLY - LAY-IN ACOUSTIC CEILING TILE</p> <ul style="list-style-type: none">- LAY-IN ACOUSTIC CEILING TILE GRID AND SUPPORT SYSTEM- ACOUSTIC CEILING TILE PER FINISH SCHEDULE	 <p>C3</p>	<p>GYPSUM CEILING WITH GLUE-ON TILES</p> <ul style="list-style-type: none">- JOIST OR TRUSS PER STRUCTURAL- 1/2" GYPSUM WALL BOARD- GLUE-ON ACOUSTIC CEILING TILES PER SPEC <p>*SEE REFLECTED CEILING PLAN FOR CEILING PANEL LAYOUT</p>
 <p>C1</p>	<p>CEILING ASSEMBLY - GYPSUM CEILING & SOFFIT</p> <ul style="list-style-type: none">- TRANSVERSE RUNNER TRACK HUNG BY SPACED HANGER WIRE- METAL FURRING CHANNELS AT 16" O.C.- 1/2" GYPSUM WALL BOARD	 <p>C4</p>	<p>FRAMED STRUCTURE WITH GYPSUM CEILING</p> <ul style="list-style-type: none">- WOOD FRAMING- 1/2" GYPSUM WALL BOARD <p>*SEE WALL SECTIONS AND DETAILS FOR SOFFIT FRAMING</p>







CEILING ASSEMBLIES

 <p>R3</p>	<p>ROOF / CEILING ASSEMBLY</p> <ul style="list-style-type: none">- FULLY ADHERED TPO ROOF- FULLY ANCHORED 1/2" GLASS MAT COVER BOARD- 6 1/2" RIGID INSULATION (R-38)- VAPOR BARRIER- PLYWOOD SHEATHING PER STRUCTURAL- MANUFACTURED TRUSS PER STRUCTURAL- CEILING BELOW PER REFLECTED CEILING PLAN
 <p>R2</p>	<p>ROOF / CEILING ASSEMBLY</p> <ul style="list-style-type: none">- LAMINATED ASPHALTIC SHINGLES- WEATHER RESISTIVE BARRIER- PLYWOOD ROOF SHEATHING PER STRUCTURAL- TJI PER STRUCTURAL- 1-1/2" CONTINUOUS AIR GAP- R-60 FACED BATT INSULATION WITH VINYL STRAPPING, STAGGER BATT JOINTS, TYPICAL- METAL Z FURRING CHANNEL- CEILING BELOW PER REFLECTED CEILING PLAN
 <p>R1</p>	<p>ROOF / CEILING ASSEMBLY</p> <ul style="list-style-type: none">- LAMINATED ASPHALTIC SHINGLES- WEATHER RESISTIVE BARRIER- PLYWOOD ROOF SHEATHING PER STRUCTURAL- MANUFACTURED TRUSS PER STRUCTURAL- 1-1/2" CONTINUOUS AIR GAP- R-60 FACED BATT INSULATION WITH VINYL STRAPPING, STAGGER BATT JOINTS, TYPICAL- CEILING BELOW PER REFLECTED CEILING PLAN







ROOF ASSEMBLIES - STANDARD FRAMING

 <p>F2</p>	<p>MECHANICAL PLATFORM FLOOR/CEILING</p> <ul style="list-style-type: none">- PLYWOOD SHEATHING - SEE STRUCTURAL- 11 1/8" JOISTS - SEE STRUCTURAL- 3 1/2" ACOUSTICAL BATT INSULATION IN JOIST BAY- CEILING PER REFLECTED CEILING PLAN
 <p>F1</p>	<p>CONCRETE MAT SLAB</p> <ul style="list-style-type: none">- FLOOR FINISH PER FINISH PLAN- 14" REINFORCED CONCRETE MAT SLAB - SEE STRUCTURAL- UNDER SLAB VAPOR RETARDER- 6" PEA GRAVEL CAPILLARY BREAK- MIN. 18" COMPACTED STRUCTURAL FILL PER GEOTECH REPORT


FLOOR ASSEMBLIES

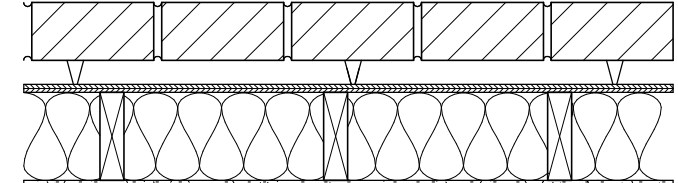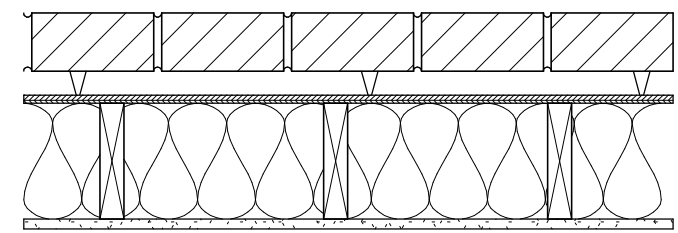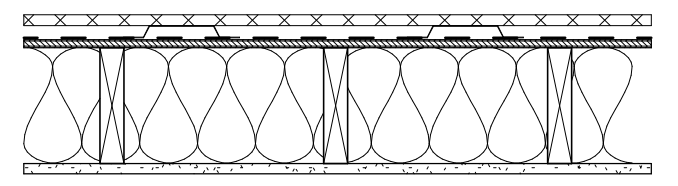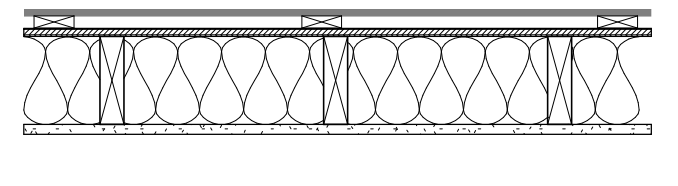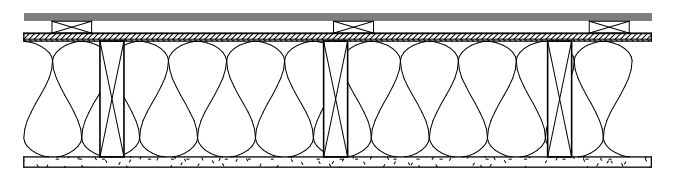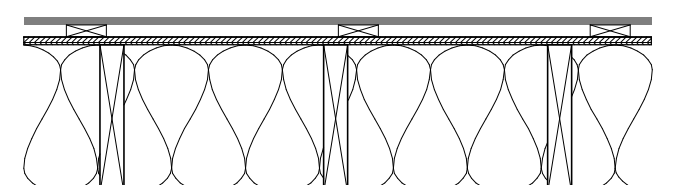 <p>E6</p>	<p>EXTERIOR WALL WITH BRICK VENEER</p> <ul style="list-style-type: none">- BRICK VENEER TO MATCH CHURCH- 1-1/2" AIR GAP WITH SEISMIC TIES- VAPOR PERMEABLE WEATHER RESISTANT BARRIER- PLYWOOD SHEATHING- 2X6 WOOD STUDS PER STRUCTURAL- R-21 BATT INSULATION- 5/8" GYPSUM WALL BOARD <p>LOAD-BEARING</p>
 <p>E5</p>	<p>EXTERIOR WALL WITH BRICK VENEER</p> <ul style="list-style-type: none">- BRICK VENEER TO MATCH CHURCH- 1-1/2" AIR GAP WITH SEISMIC TIES- VAPOR PERMEABLE WEATHER RESISTANT BARRIER- PLYWOOD SHEATHING- 2X8 WOOD STUDS PER STRUCTURAL- R-25 BATT INSULATION- 5/8" GYPSUM WALL BOARD <p>LOAD-BEARING</p>
 <p>E4</p>	<p>EXTERIOR WALL WITH STUCCO SIDING</p> <ul style="list-style-type: none">- STUCCO- METAL LATH- 3/4" VERTICAL GALVANIZED HAT CHANNELS- VAPOR PERMEABLE WEATHER RESISTANT BARRIER- PLYWOOD SHEATHING- 2X8 WOOD STUDS PER STRUCTURAL / FURRING- R-25 BATT INSULATION- 5/8" GYPSUM WALL BOARD <p>LOAD-BEARING</p>
 <p>E3</p>	<p>EXTERIOR WALL WITH SIDING</p> <ul style="list-style-type: none">- SIDING PER ELEVATION- 3/4" VERTICAL FURRING STRIPS- VAPOR PERMEABLE WEATHER RESISTANT BARRIER- PLYWOOD SHEATHING- 2X6 WOOD STUDS PER STRUCTURAL- R-21 BATT INSULATION- 5/8" GYPSUM WALL BOARD <p>LOAD-BEARING</p>
 <p>E2</p>	<p>2X9 OR LVL EXTERIOR WALL WITH SIDING</p> <ul style="list-style-type: none">- SIDING PER ELEVATION- 3/4" VERTICAL FURRING STRIPS- VAPOR PERMEABLE WEATHER RESISTANT BARRIER- PLYWOOD SHEATHING- 2X6 WOOD STUDS PER STRUCTURAL- R-25 BATT INSULATION- 5/8" GYPSUM WALL BOARD <p>LOAD-BEARING</p>
 <p>E1</p>	<p>2X10 OR LVL EXTERIOR WALL WITH SIDING</p> <ul style="list-style-type: none">- SIDING PER ELEVATION- 3/4" VERTICAL FURRING STRIPS- VAPOR PERMEABLE WEATHER RESISTANT BARRIER- PLYWOOD SHEATHING- 2X10 WOOD STUDS PER STRUCTURAL- R-25 BATT INSULATION- 5/8" GYPSUM WALL BOARD <p>LOAD-BEARING</p>

EXTERIOR WALL ASSEMBLIES - STANDARD FRAMING

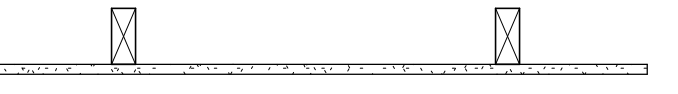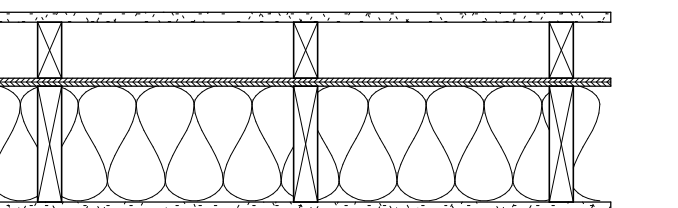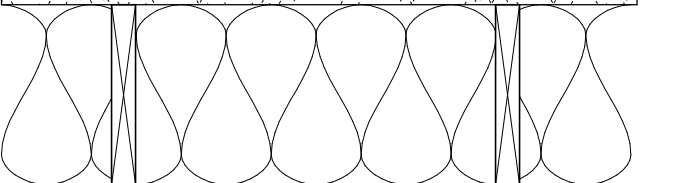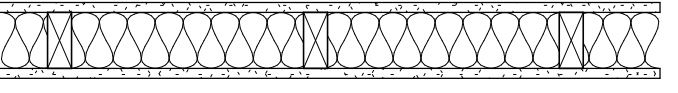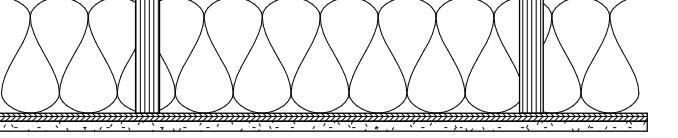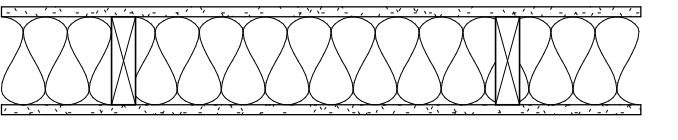 <p>W6</p>	<p>INTERIOR FURRING WALL</p> <ul style="list-style-type: none">- 2x STUDS- 5/8" TYPE X GYPSUM WALL BOARD
 <p>W5</p>	<p>2X8 AND 2X4 WOOD FRAMED COMPOUND SHEAR WALL</p> <ul style="list-style-type: none">- 5/8" TYPE X GYPSUM WALL BOARD- 2x4 STUDS PER STRUCTURAL- 1/2" PLYWOOD SHEATHING- 2X8 STUDS PER STRUCTURAL- UNFACED GLASS FIBER SOUND BATT INSULATION, FULL STUD DEPTH- 5/8" TYPE X GYPSUM WALL BOARD <p>1-HOUR FIRE RATED AT KITCHEN LOCATION</p>
 <p>W4</p>	<p>INTERIOR WALL ASSEMBLY</p> <ul style="list-style-type: none">- 5/8" TYPE X GYPSUM WALL BOARD- 2x12 STUDS PER STRUCTURAL- UNFACED GLASS FIBER SOUND BATT INSULATION, FULL STUD DEPTH- 5/8" TYPE X GYPSUM WALL BOARD <p>1-HOUR FIRE RATED AT KITCHEN LOCATION</p>
 <p>W3</p>	<p>INTERIOR WALL ASSEMBLY</p> <ul style="list-style-type: none">- 5/8" TYPE X GYPSUM WALL BOARD- 2x4 STUDS PER STRUCTURAL- UNFACED GLASS FIBER SOUND BATT INSULATION, FULL STUD DEPTH- 5/8" TYPE X GYPSUM WALL BOARD
 <p>W2</p>	<p>INTERIOR SHEAR WALL</p> <ul style="list-style-type: none">- 5/8" TYPE X GYPSUM WALL BOARD- LVL PER STRUCTURAL- GLASS FIBER SOUND BATT INSULATION- 1/2" PLYWOOD SHEATHING- 5/8" TYPE X GYPSUM WALL BOARD
 <p>W1</p>	<p>INTERIOR WALL ASSEMBLY</p> <ul style="list-style-type: none">- 5/8" TYPE X GYPSUM WALL BOARD- 2x6 STUDS PER STRUCTURAL- GLASS FIBER SOUND BATT INSULATION- 5/8" TYPE X GYPSUM WALL BOARD <p>1-HOUR FIRE RATED AT KITCHEN LOCATION</p>

INTERIOR WALL ASSEMBLIES - STANDARD FRAMING

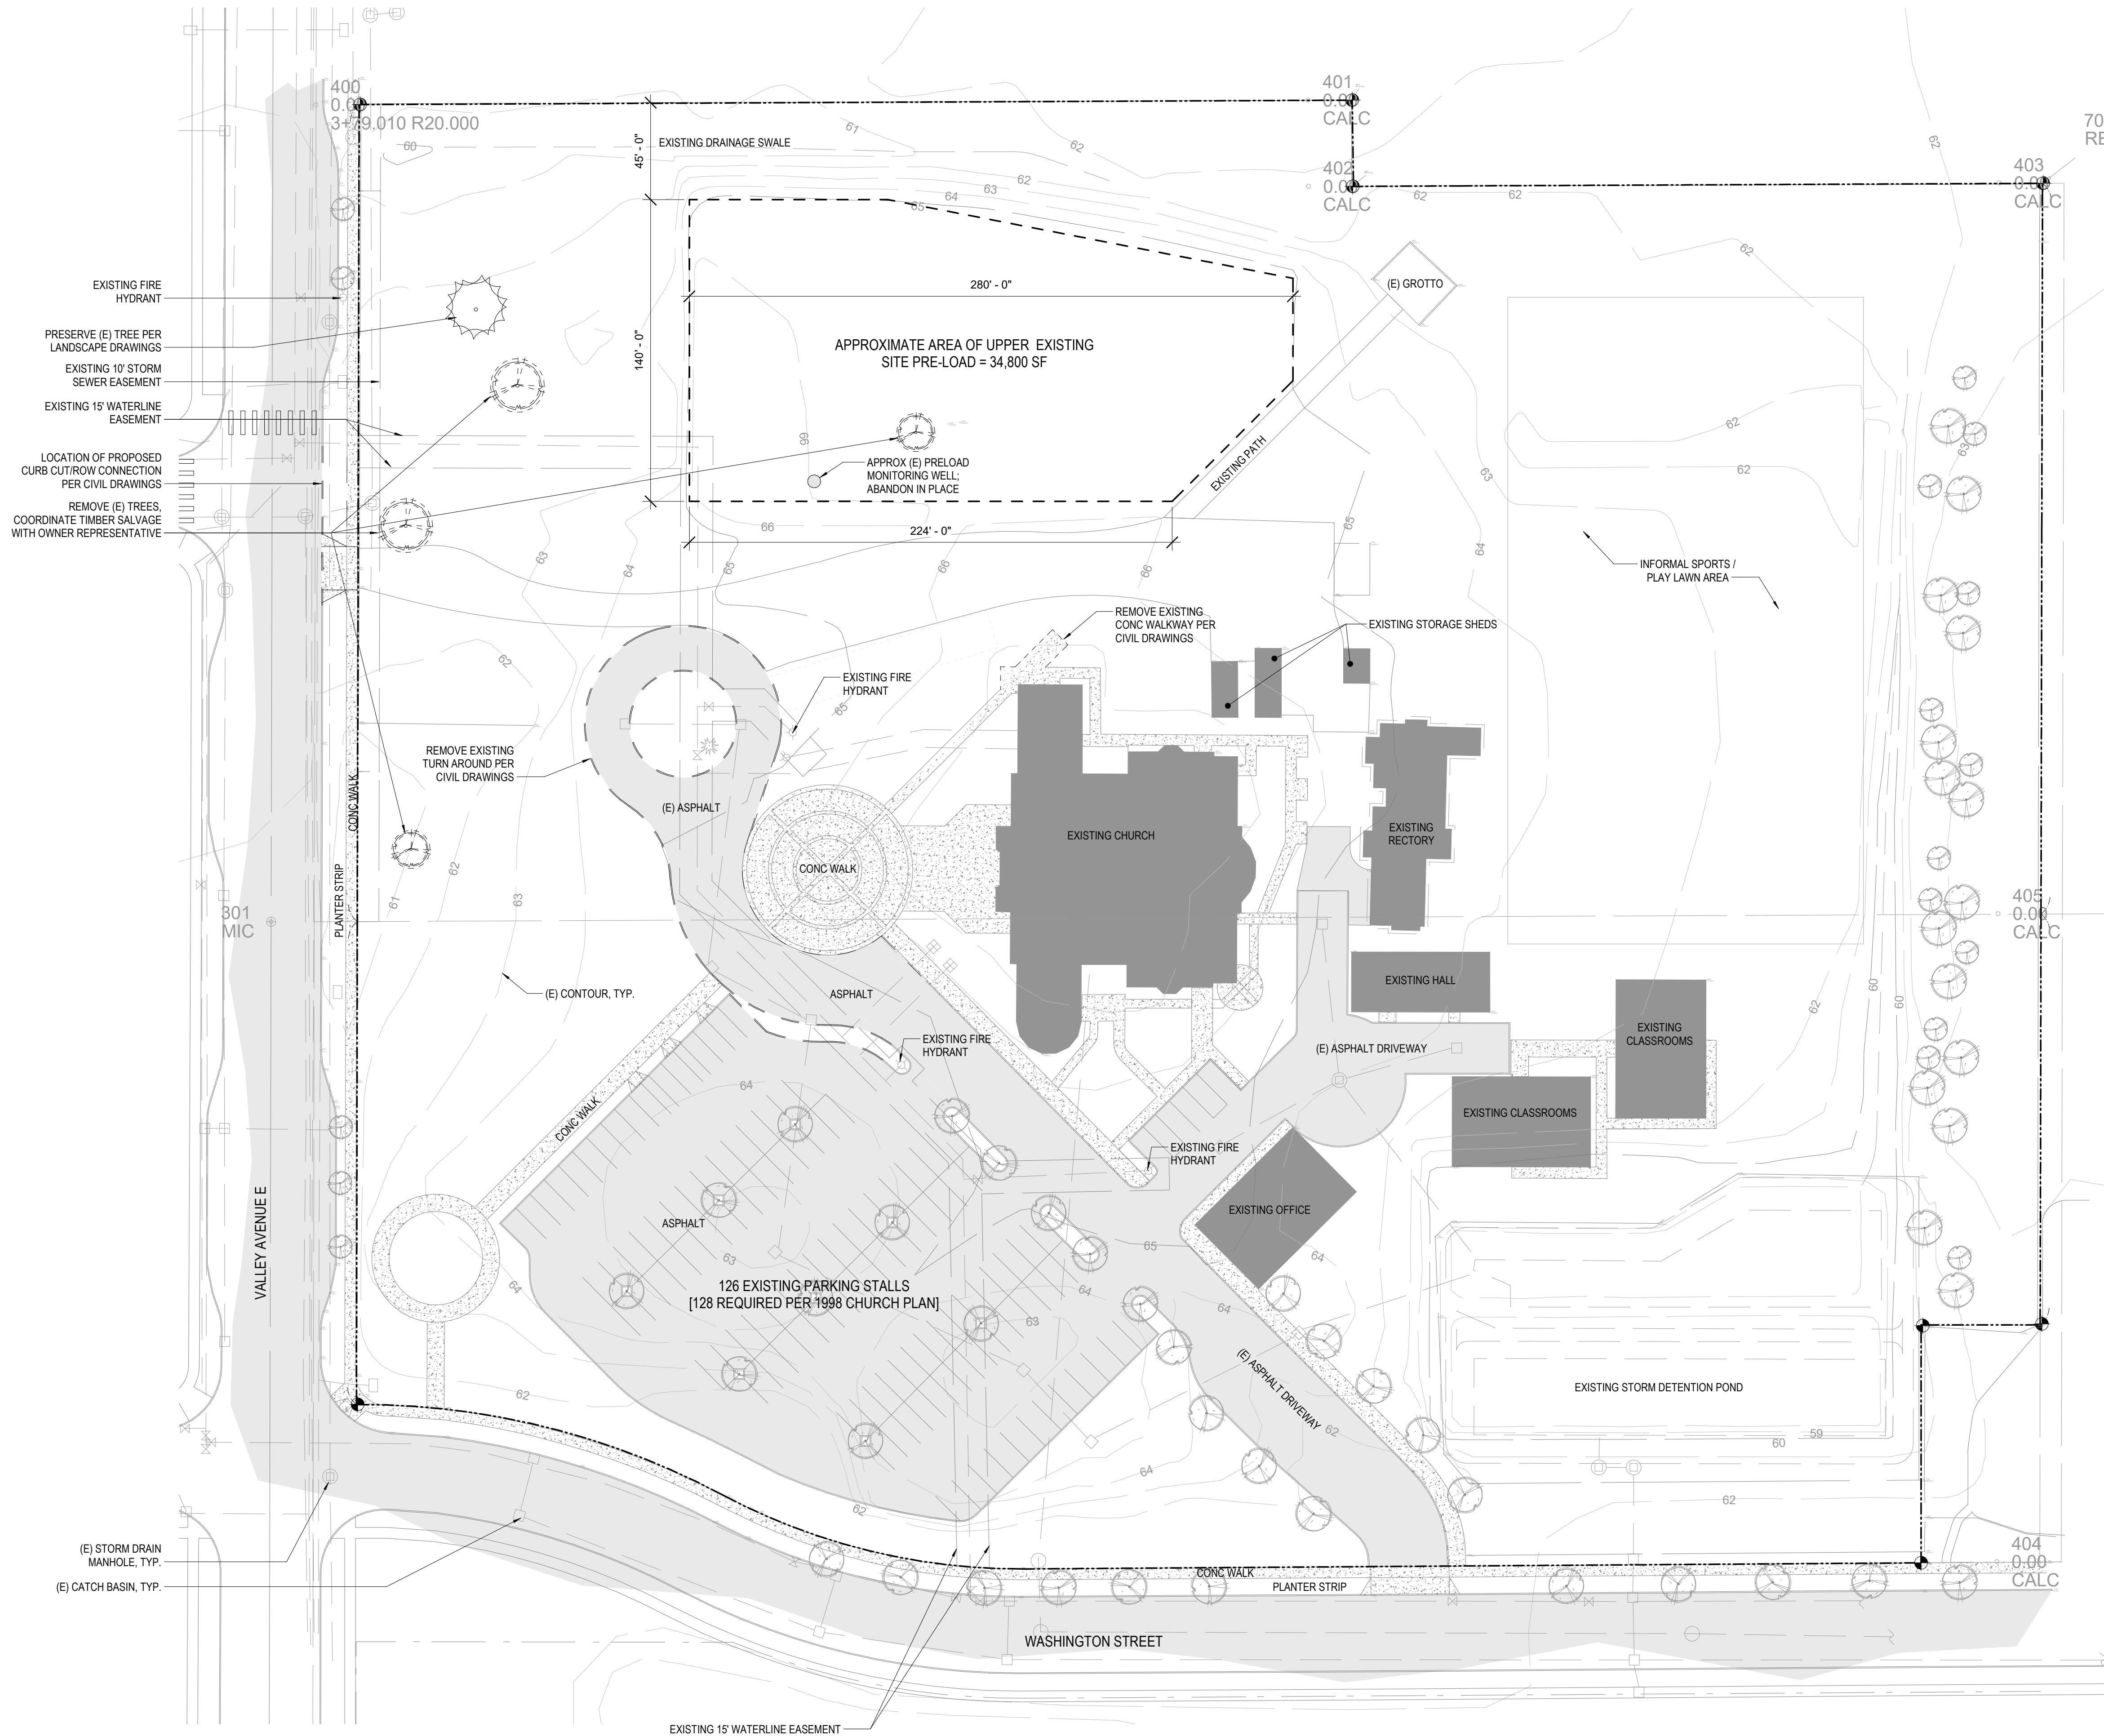

SHEET NOTES

1. REFER TO CIVIL DRAWINGS FOR ADDITIONAL EXISTING SITE ELEMENTS, SITE CONDITIONS, AND PROPOSED NEW IMPROVEMENTS.
2. PROTECT ALL EXISTING STRUCTURES AND UTILITIES.
3. SEE LANDSCAPE DRAWINGS FOR ALL NEW LANDSCAPE AND IRRIGATION IMPROVEMENTS.
4. ALL GENERAL NOTES HEREIN APPLY TO ALL TRADES FOR THE PROJECT AMENDED ELSEWHERE TO INCLUDE ISOLATED CONDITIONS.
5. THE DRAWINGS ARE INTENDED TO SHOW THE GENERAL ARRANGEMENT, DESIGN, AND EXTENT OF THE WORK AND ARE PARTLY DIAGRAMMATIC - THEY ARE NOT INTENDED TO BE SCALED.
6. ALL DETAILS AND SECTIONS SHOWN ON THE DRAWINGS ARE INTENDED TO BE TYPICAL AND SHALL BE CONSIDERED TO APPLY TO ANY SIMILAR SITUATION ELSEWHERE ON THE PROJECT, EXCEPT WHERE A DIFFERENT DETAIL IS SHOWN.
7. THE CONTRACTOR AND ALL SUBCONTRACTORS SHALL VERIFY ALL GRADE LINES, LEVELS, CONDITIONS, AND DIMENSIONS AT THE JOB SITE AND AS SHOWN ON THE DRAWINGS. THEY SHALL REPORT ANY ERRORS OF INCONSISTENCIES IN THE ABOVE TO THE OWNER / ARCHITECT BEFORE COMMENCING WORK.
8. THE CONTRACTOR AND ALL SUBCONTRACTORS SHALL LAY OUT THEIR WORK FROM ESTABLISHED REFERENCE POINTS AND BE ESTABLISHED REFERENCE POINTS AND BE RESPONSIBLE FOR ALL LINES, ELEVATIONS, AND MEASUREMENTS IN CONNECTION WITH THEIR OWN SCOPE.
9. PROTECTION
 - A. THE CONTRACTOR IS RESPONSIBLE AND SHALL COMPLY WITH THE REQUIREMENTS OF THE BUILDING CODE HAVING JURISDICTION AND ALL LOCAL, STATE, AND FEDERAL LAWS.
 - B. PROVIDE ALL SHORING AND BRACING AS REQUIRED FOR THE PROPER EXECUTION OF THE WORK - REMOVE WHEN WORK IS COMPLETED.
 - C. PROVIDE AND MAINTAIN SAFETY LIGHTING AND BARRICADES AT ALL AREAS OF WORK ADJACENT TO PUBLIC WAYS OR PUBLIC SPACES.
 - D. AT ALL TIMES PROVIDE PROTECTION AGAINST WEATHER (RAIN, WIND, STORMS, OR HEAT) SO AS TO MAINTAIN ALL WORK, MATERIALS, APPARATUS, AND FIXTURES FREE FROM DAMAGE.
 - E. THE CONTRACTOR SHALL PAY FOR ALL DAMAGES TO ADJACENT STRUCTURES, SIDEWALKS, AND STREETS OR OTHER PUBLIC PROPERTY OR TO ANY PUBLIC UTILITIES.
10. IF ANY UNCERTAINTIES APPEAR IN THE DRAWINGS, SPECIFICATIONS, OR OTHER DOCUMENTS, THE CONTRACTOR SHALL NOTIFY THE PROJECT MGR. / ARCHITECT IN WRITING OF SUCH ITEMS PRIOR TO PROCEEDING WITH ANY WORK WHICH APPEARS IN QUESTION. IN THE EVENT OF THE CONTRACTOR'S FAILING TO GIVE SUCH NOTICE, THEY SHALL BE HELD RESPONSIBLE FOR THE RESULTS OF ANY SUCH OMISSIONS AND THE COST OF RECTIFYING THE SAME. THE CONTRACTOR SHALL HAVE ALL ITEMS OR DETAILS CLARIFIED WITH THE PROJECT MGR. / ARCHITECT PRIOR TO SUBMITTING A BID; OTHERWISE THE ARCHITECT'S INTERPRETATION SHALL BE FINAL.
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2 Existing Site Plan

1" = 40'-0"

RMC ARCHITECTS




Archdiocese of Seattle
St. Andrew Catholic Church Parish Hall
1401 Valley Avenue East
Sumner, WA 98390-2720

Job No.: 1851 Date: 2020-02-07
File No.: 1851 St. Andrew Parish Hall
Drawn By: JW, AMR
Checked By: BPC
Issued for: PERMIT SET

EXISTING SITE
PLAN

A100

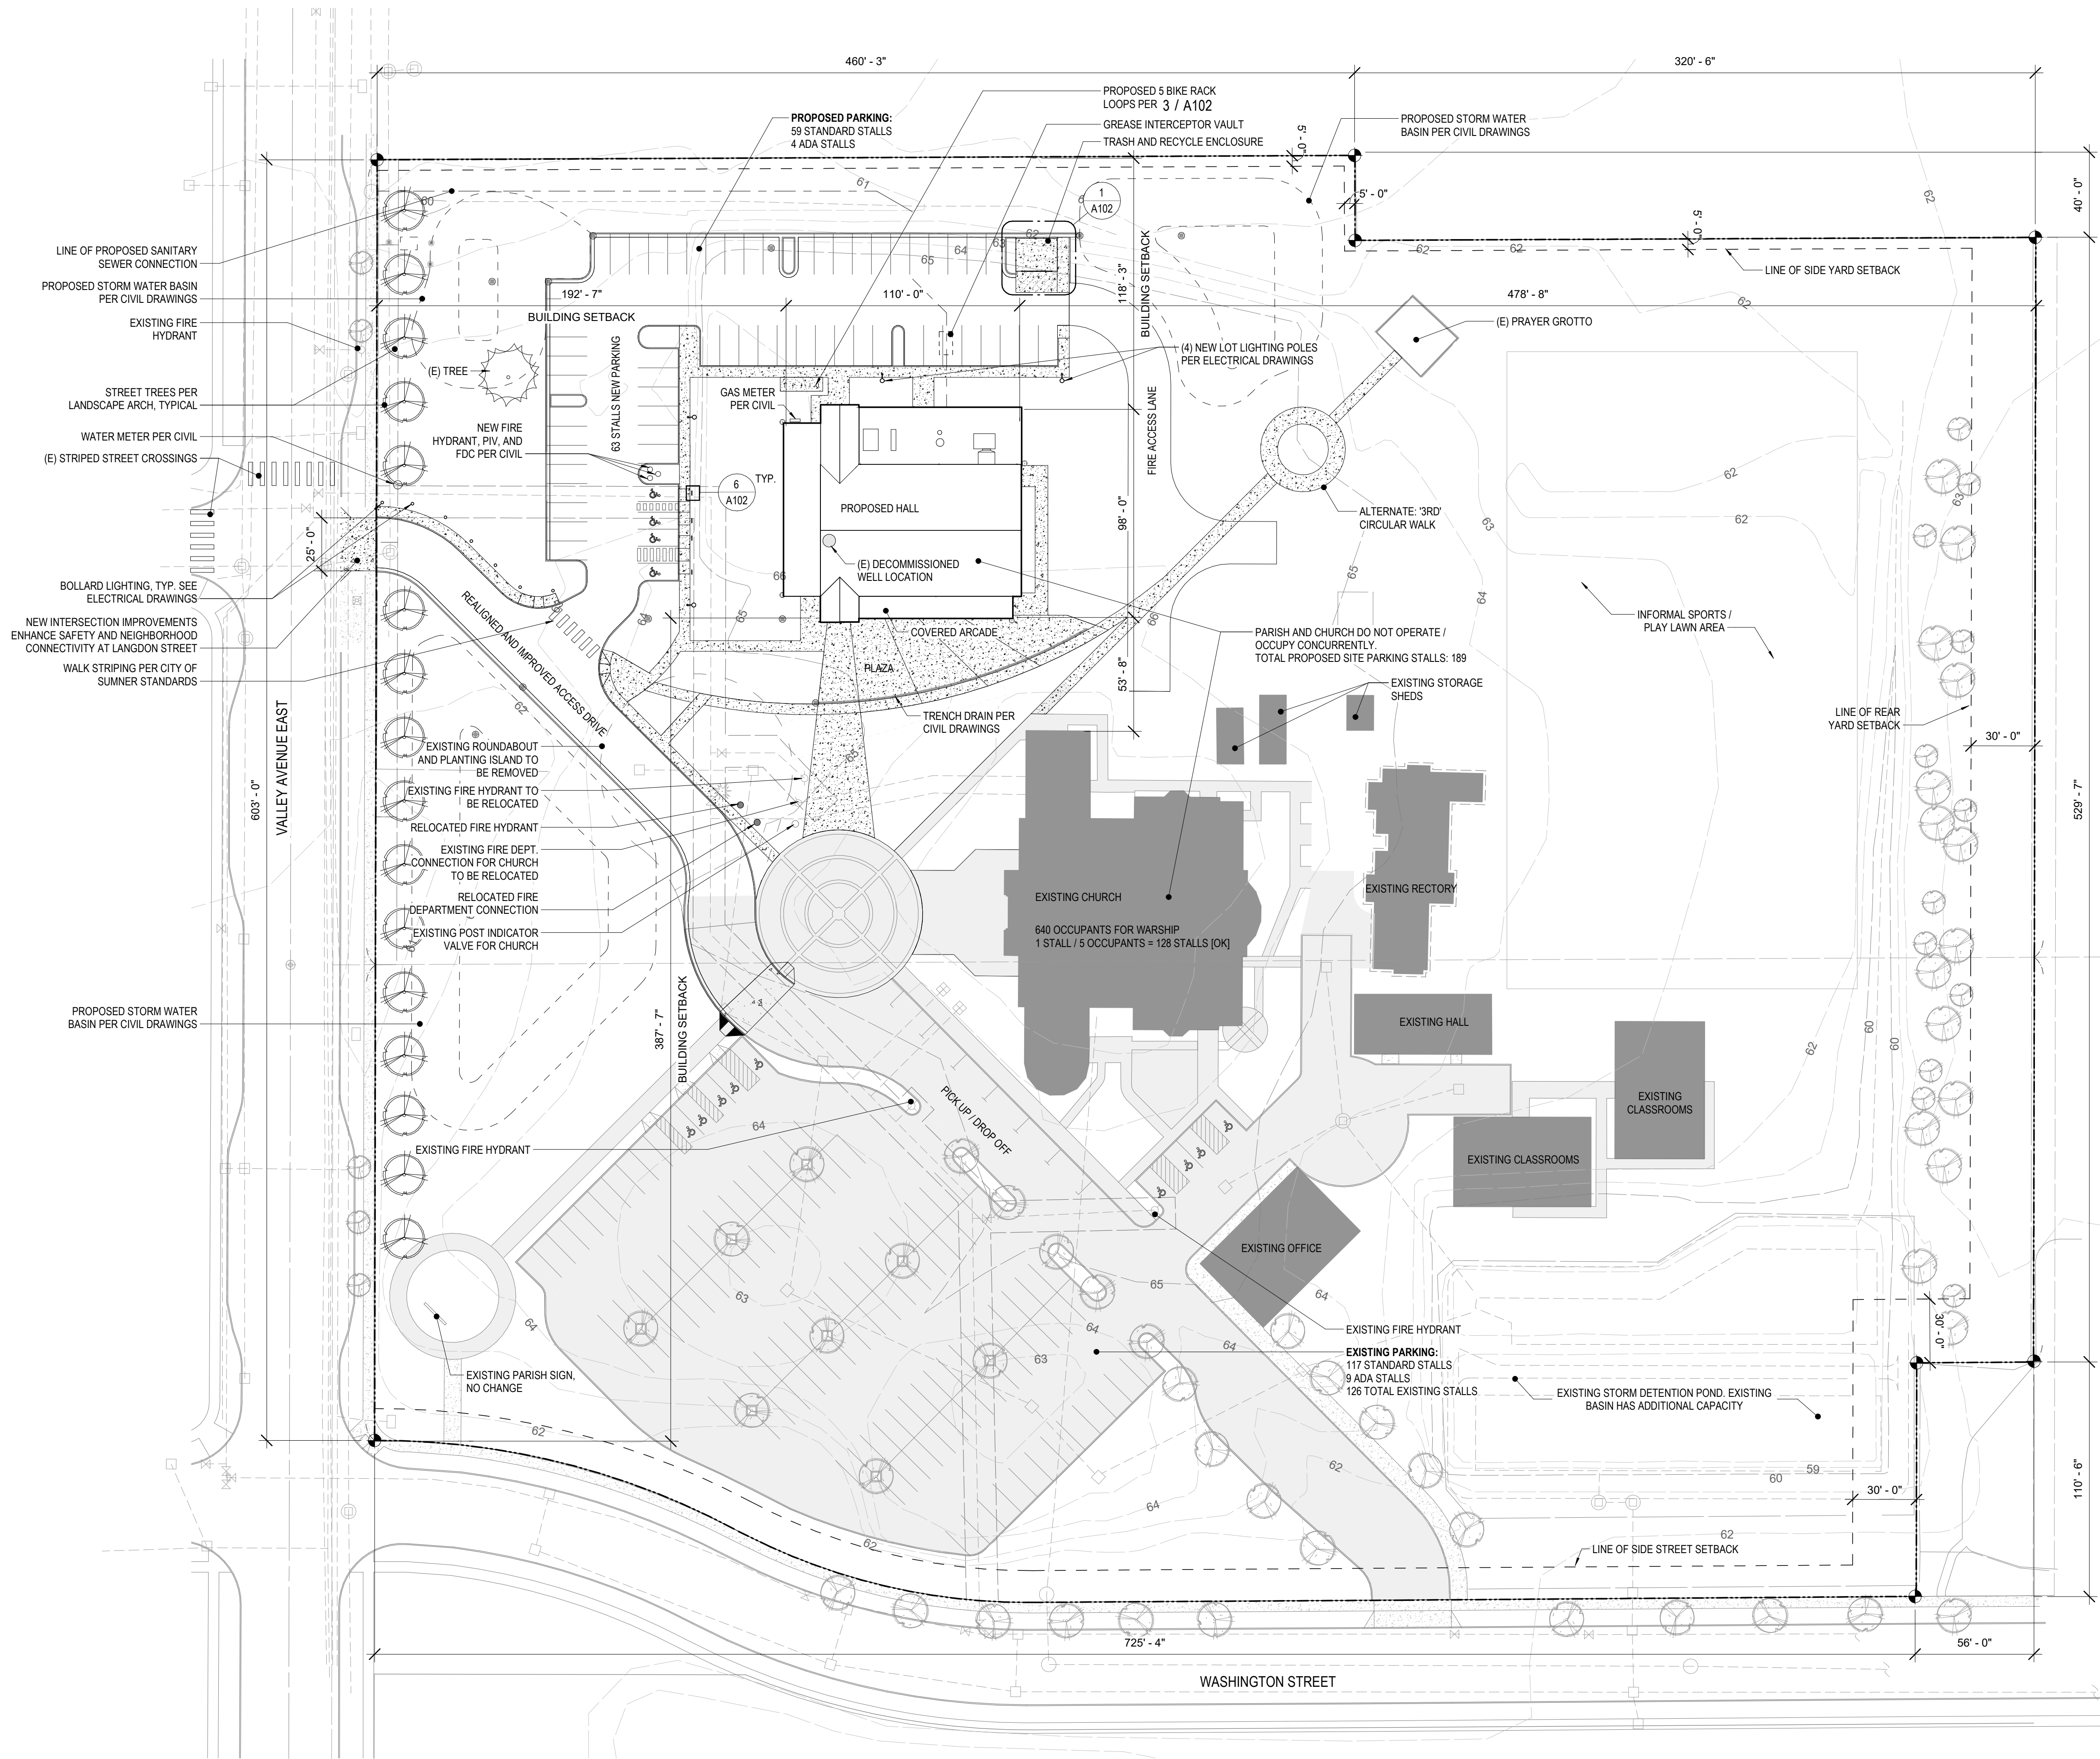

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RMC ARCHITECTS



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SITE PLAN

A101





PRODUCT DETAILS:
MANUFACTURER: URBAN RACKS
MODEL: URBAN STAPLE - UB-1000-STD
INSTALLATION: SURFACE MOUNT
FINISH: GALVANIZED

3

Bike Rack Detail


1 1/2" = 0' 0" 6" 1' 1'-4" 2'

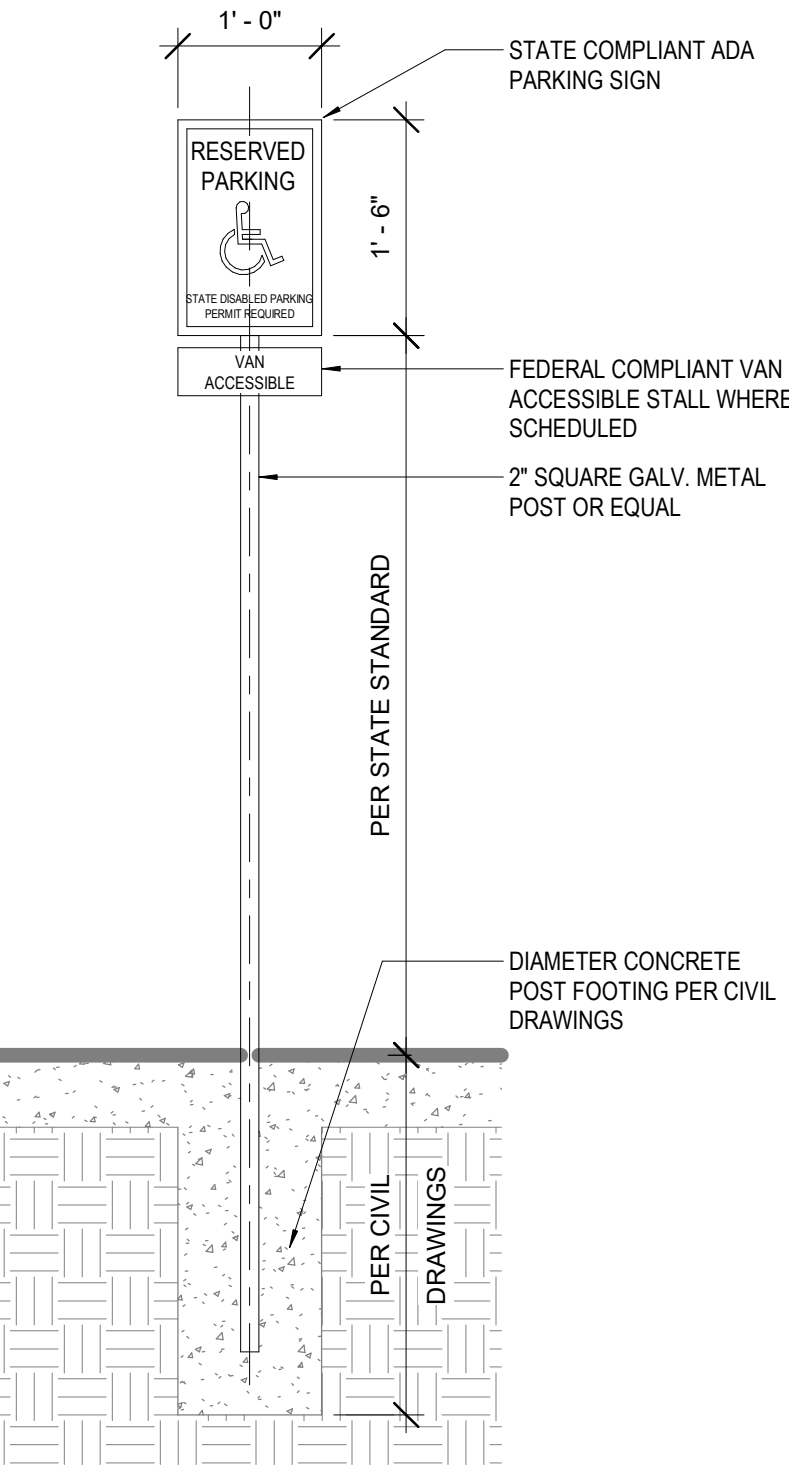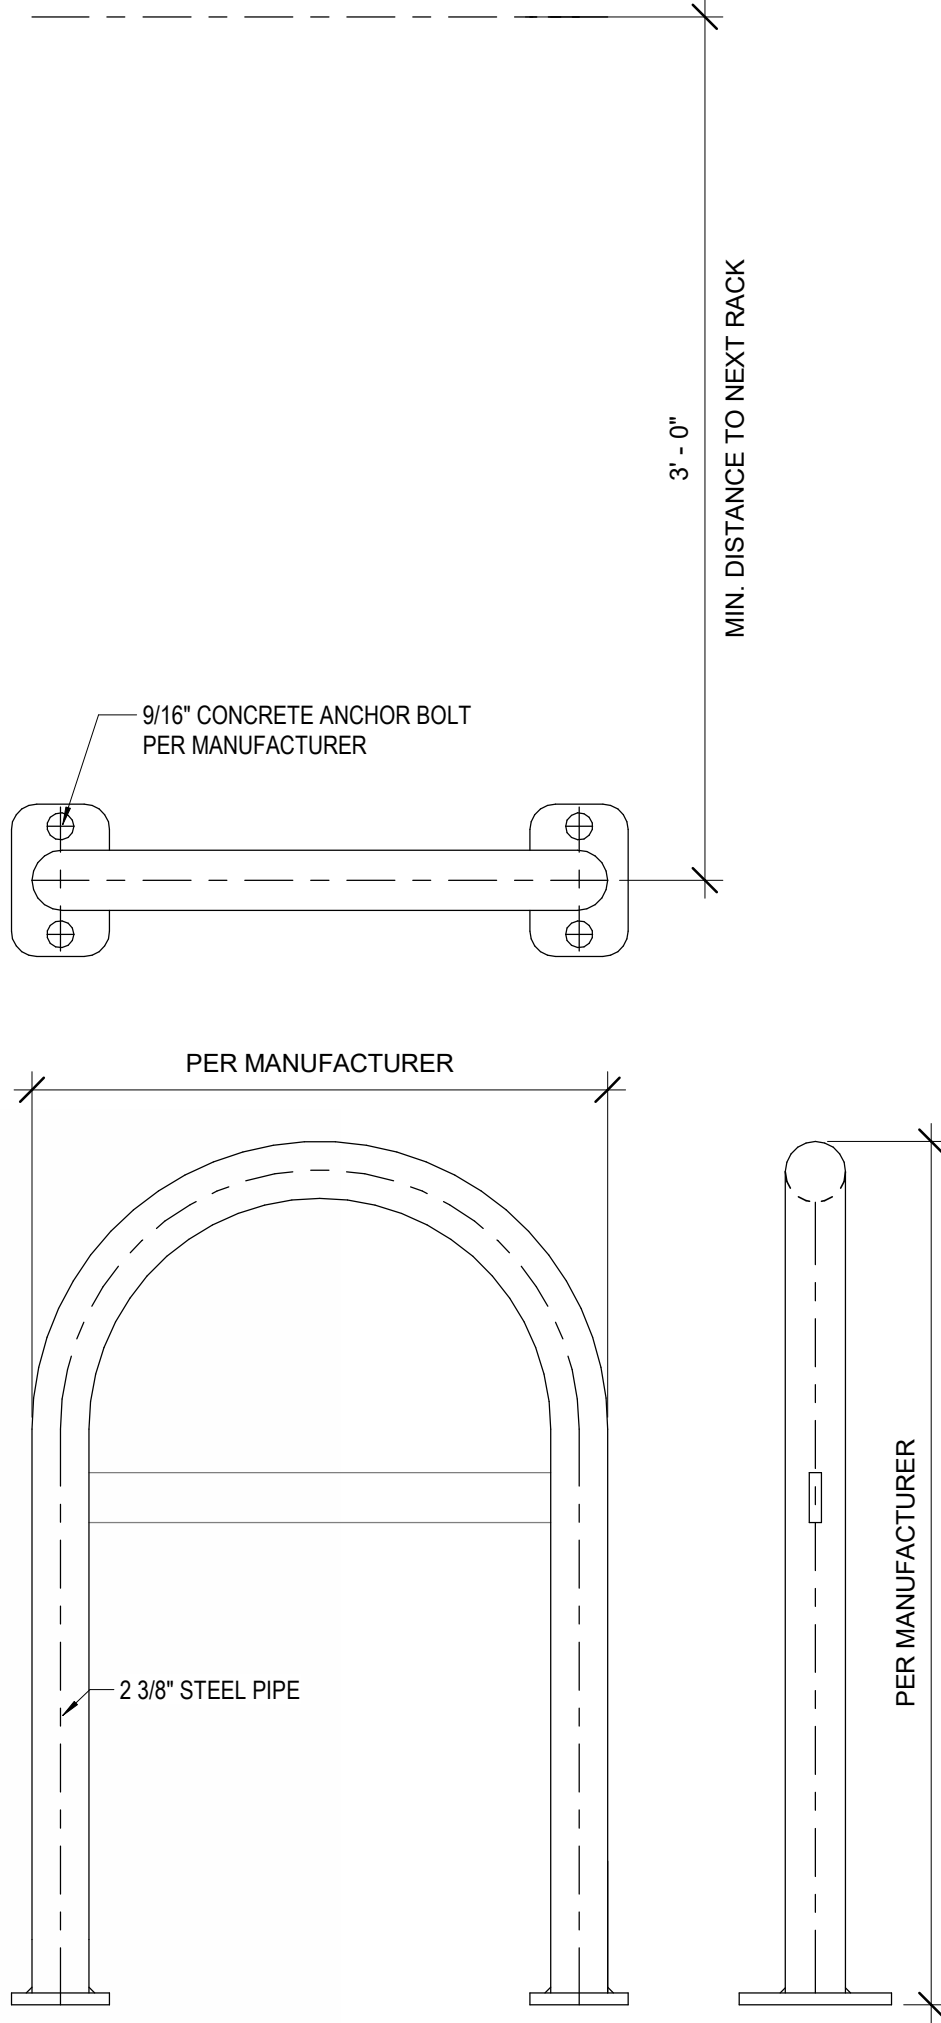

6

ADA Parking Sign


3/4" = 1'-0" 0' 1' 2' 3'

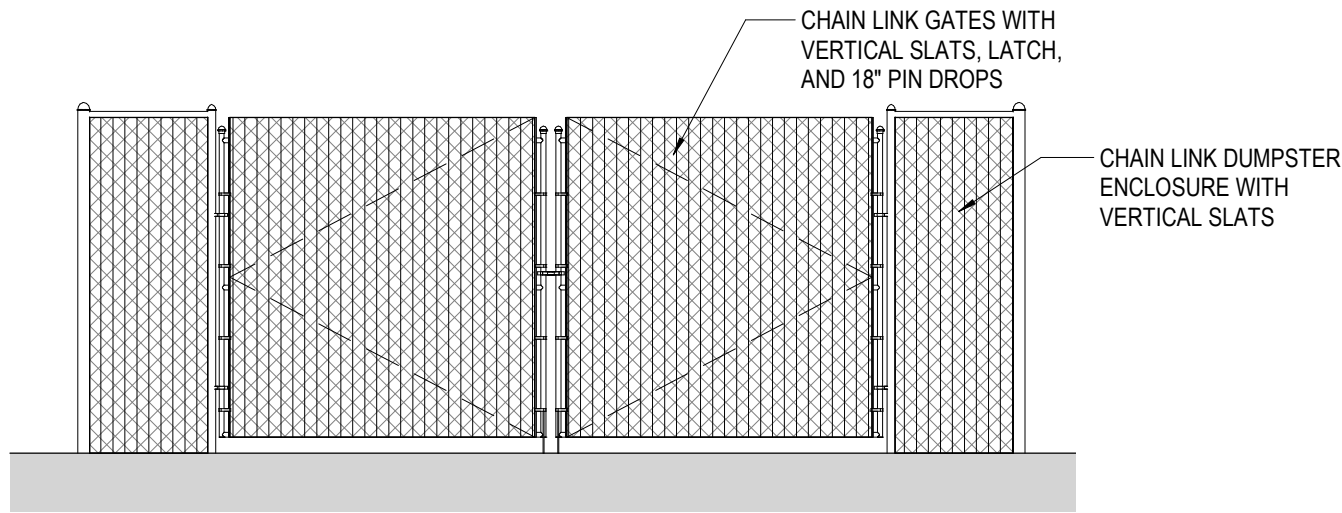

5

Dumpster Enclosure South


1/4" = 1'-0"

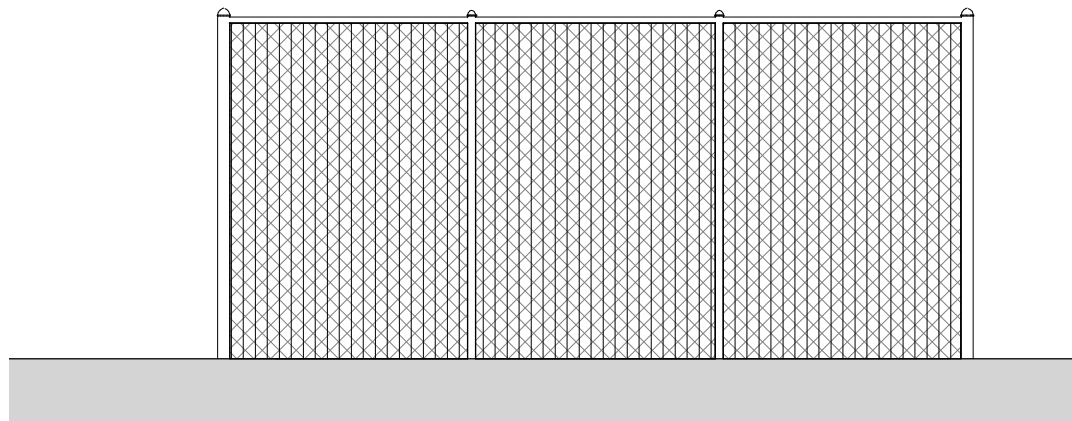

4

Dumpster Enclosure West (EAST SIM.)


1/4" = 1'-0"

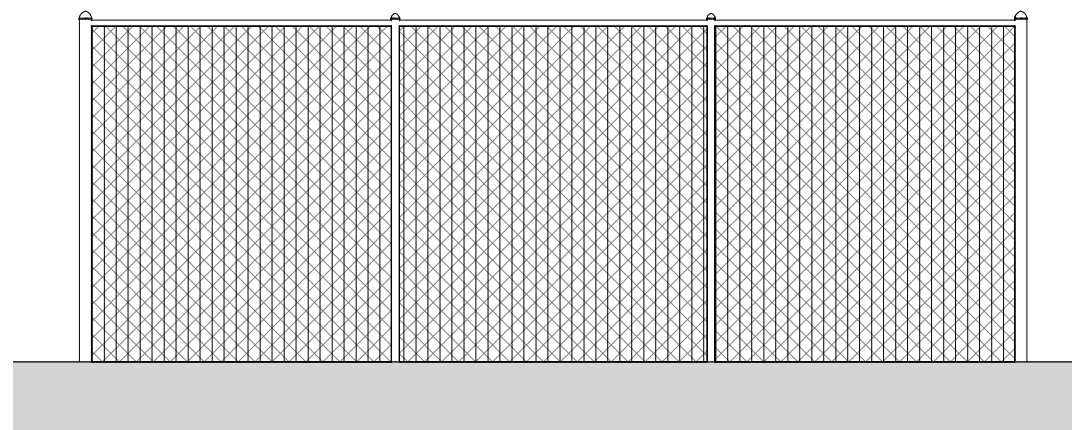

2

Dumpster Enclosure North

1/4" = 1'-0"

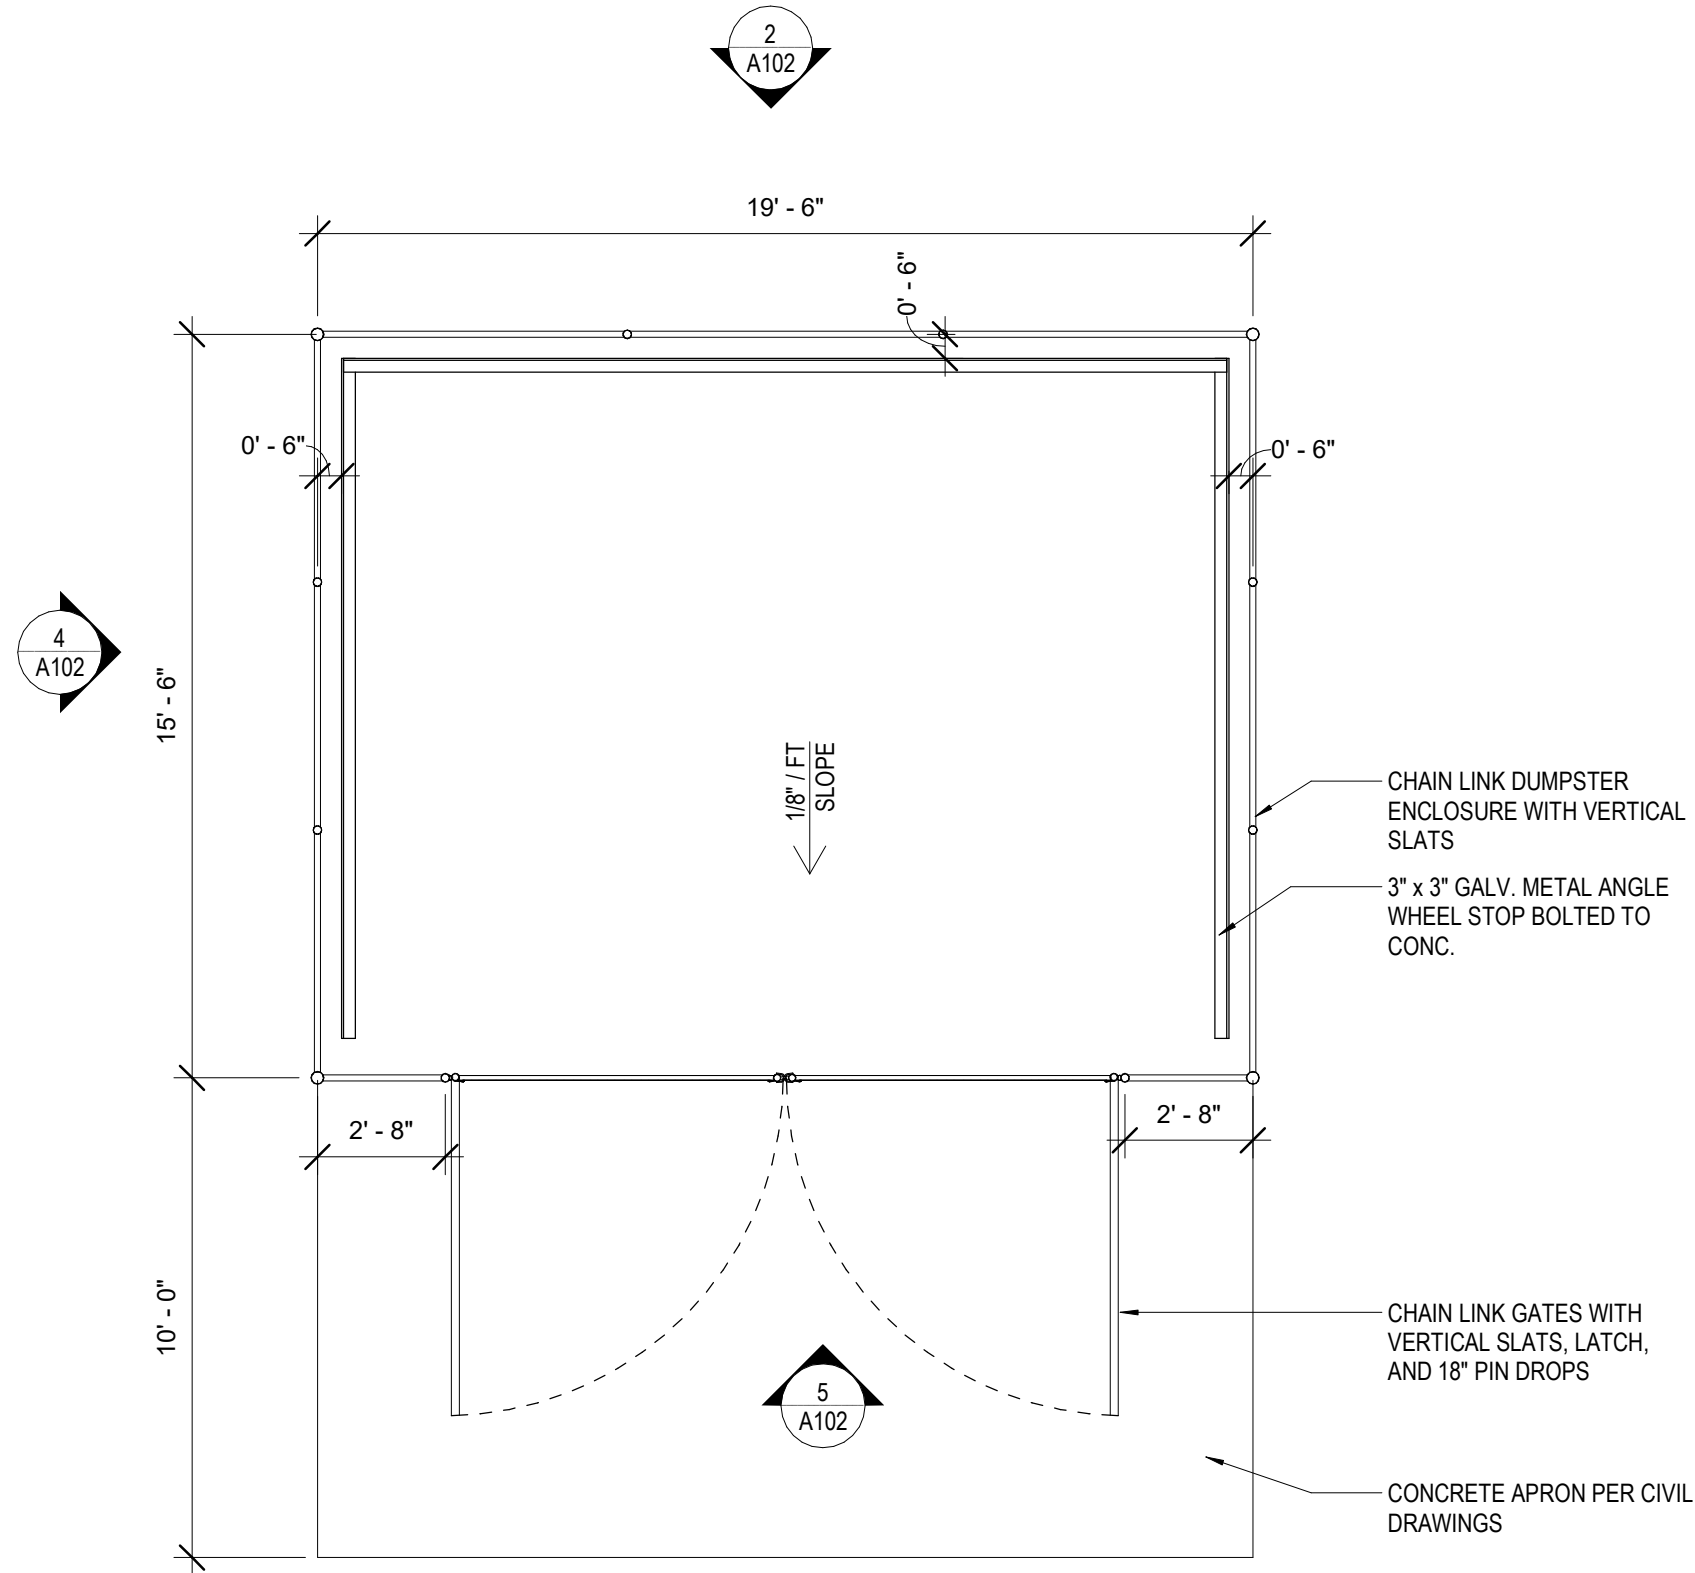

1

Dumpster Enclosure

1/4" = 1'-0" 0' 1' 2' 3'

SHEET NOTES

- DIMENSIONS SHOWN ARE FROM FACE OF STRUCTURE, TYPICAL, UNLESS NOTED OTHERWISE. SEE ASSEMBLIES FOR ADDITIONAL INFORMATION.
- PROVIDE WALL BACKING AT LOCATIONS PER PLAN, ENLARGED PLANS, AND INTERIOR ELEVATIONS, TYPICAL AT ALL CASEWORK AND WALL MOUNTED ITEMS. CONTRACTOR TO COORDINATE LOCATIONS AND EXTENTS OF WALL BACKING WITH PLANS, ENLARGED PLANS, AND INTERIOR ELEVATIONS.
- PROVIDE FIRE CAULKING AND FIRE STOPPING AT PENETRATIONS IN FIRE RESISTANCE RATED ASSEMBLIES.
- PROVIDE STAINLESS STEEL 'C' OR 'U' CORNER GUARDS, EXTEND 48" ABOVE FINISHED FLOOR, TYPICAL.
- SEE CIVIL FOR ALL EXTERIOR PAVING, WALKS, CURBS, APRONS, AND GRADING.
- SEE SPECIFICATIONS FOR ALL FOIO ITEMS, TYPICAL.
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RMC ARCHITECTS




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P: 360.676.7733 • F: 360.738.0448 • rmc@rmcarchitects.com

Archdiocese of Seattle
St. Andrew Catholic Church Parish Hall
1401 Valley Avenue East
Sumner, WA 98390-2720

Job No.: 1851 Date: 2020-02-07
File No.: 1851 St. Andrew Parish Hall
Drawn By: AMR
Checked By: BPC
Issued for: PERMIT SET

SITE DETAILS

A102

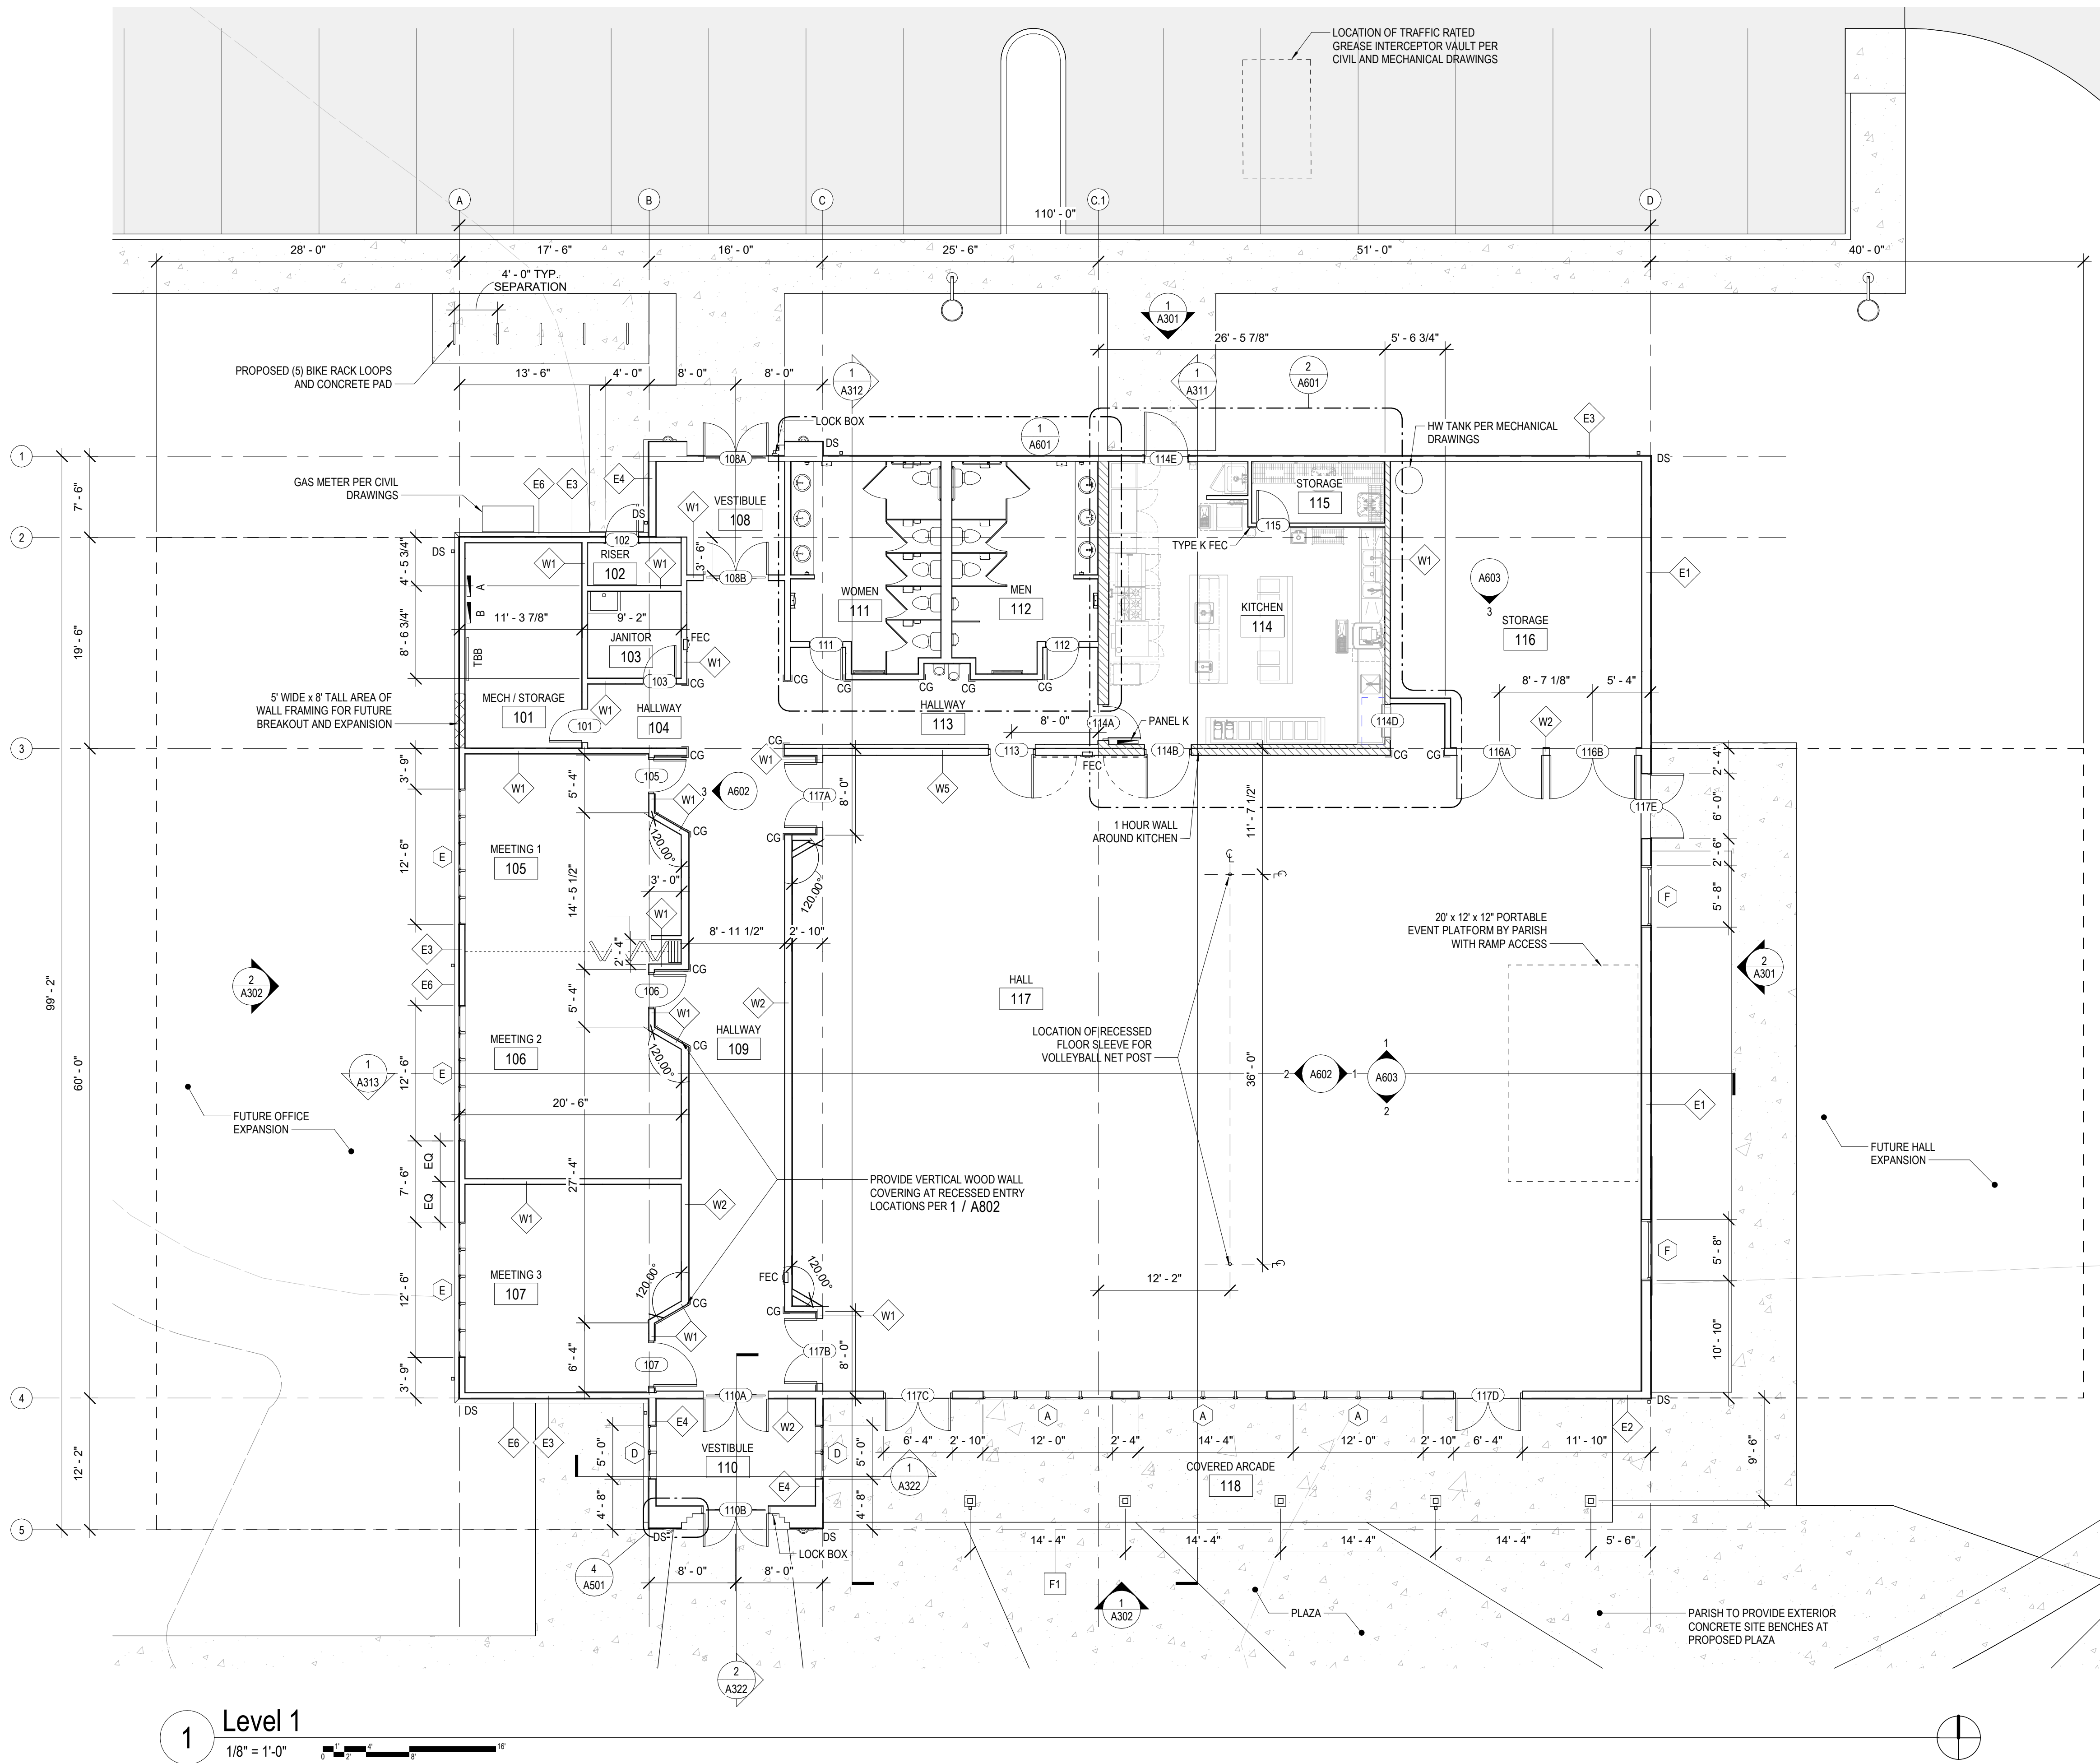

SHEET NOTES

- DIMENSIONS SHOWN ARE FROM FACE OF STRUCTURE, TYPICAL, UNLESS NOTED OTHERWISE. SEE ASSEMBLIES FOR ADDITIONAL INFORMATION.
- PROVIDE WALL BACKING AT LOCATIONS PER PLAN, ENLARGED PLANS, AND INTERIOR ELEVATIONS. TYPICAL AT ALL CASEWORK AND WALL MOUNTED ITEMS. CONTRACTOR TO COORDINATE LOCATIONS AND EXTENTS OF WALL BACKING WITH PLANS, ENLARGED PLANS, AND INTERIOR ELEVATIONS.
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RMC ARCHITECTS




Archdiocese of Seattle
St. Andrew Catholic Church Parish Hall
1401 Valley Avenue East
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Job No.: 1851 Date: 2020-02-07
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Issued for: PERMIT SET

FLOOR PLAN

A201

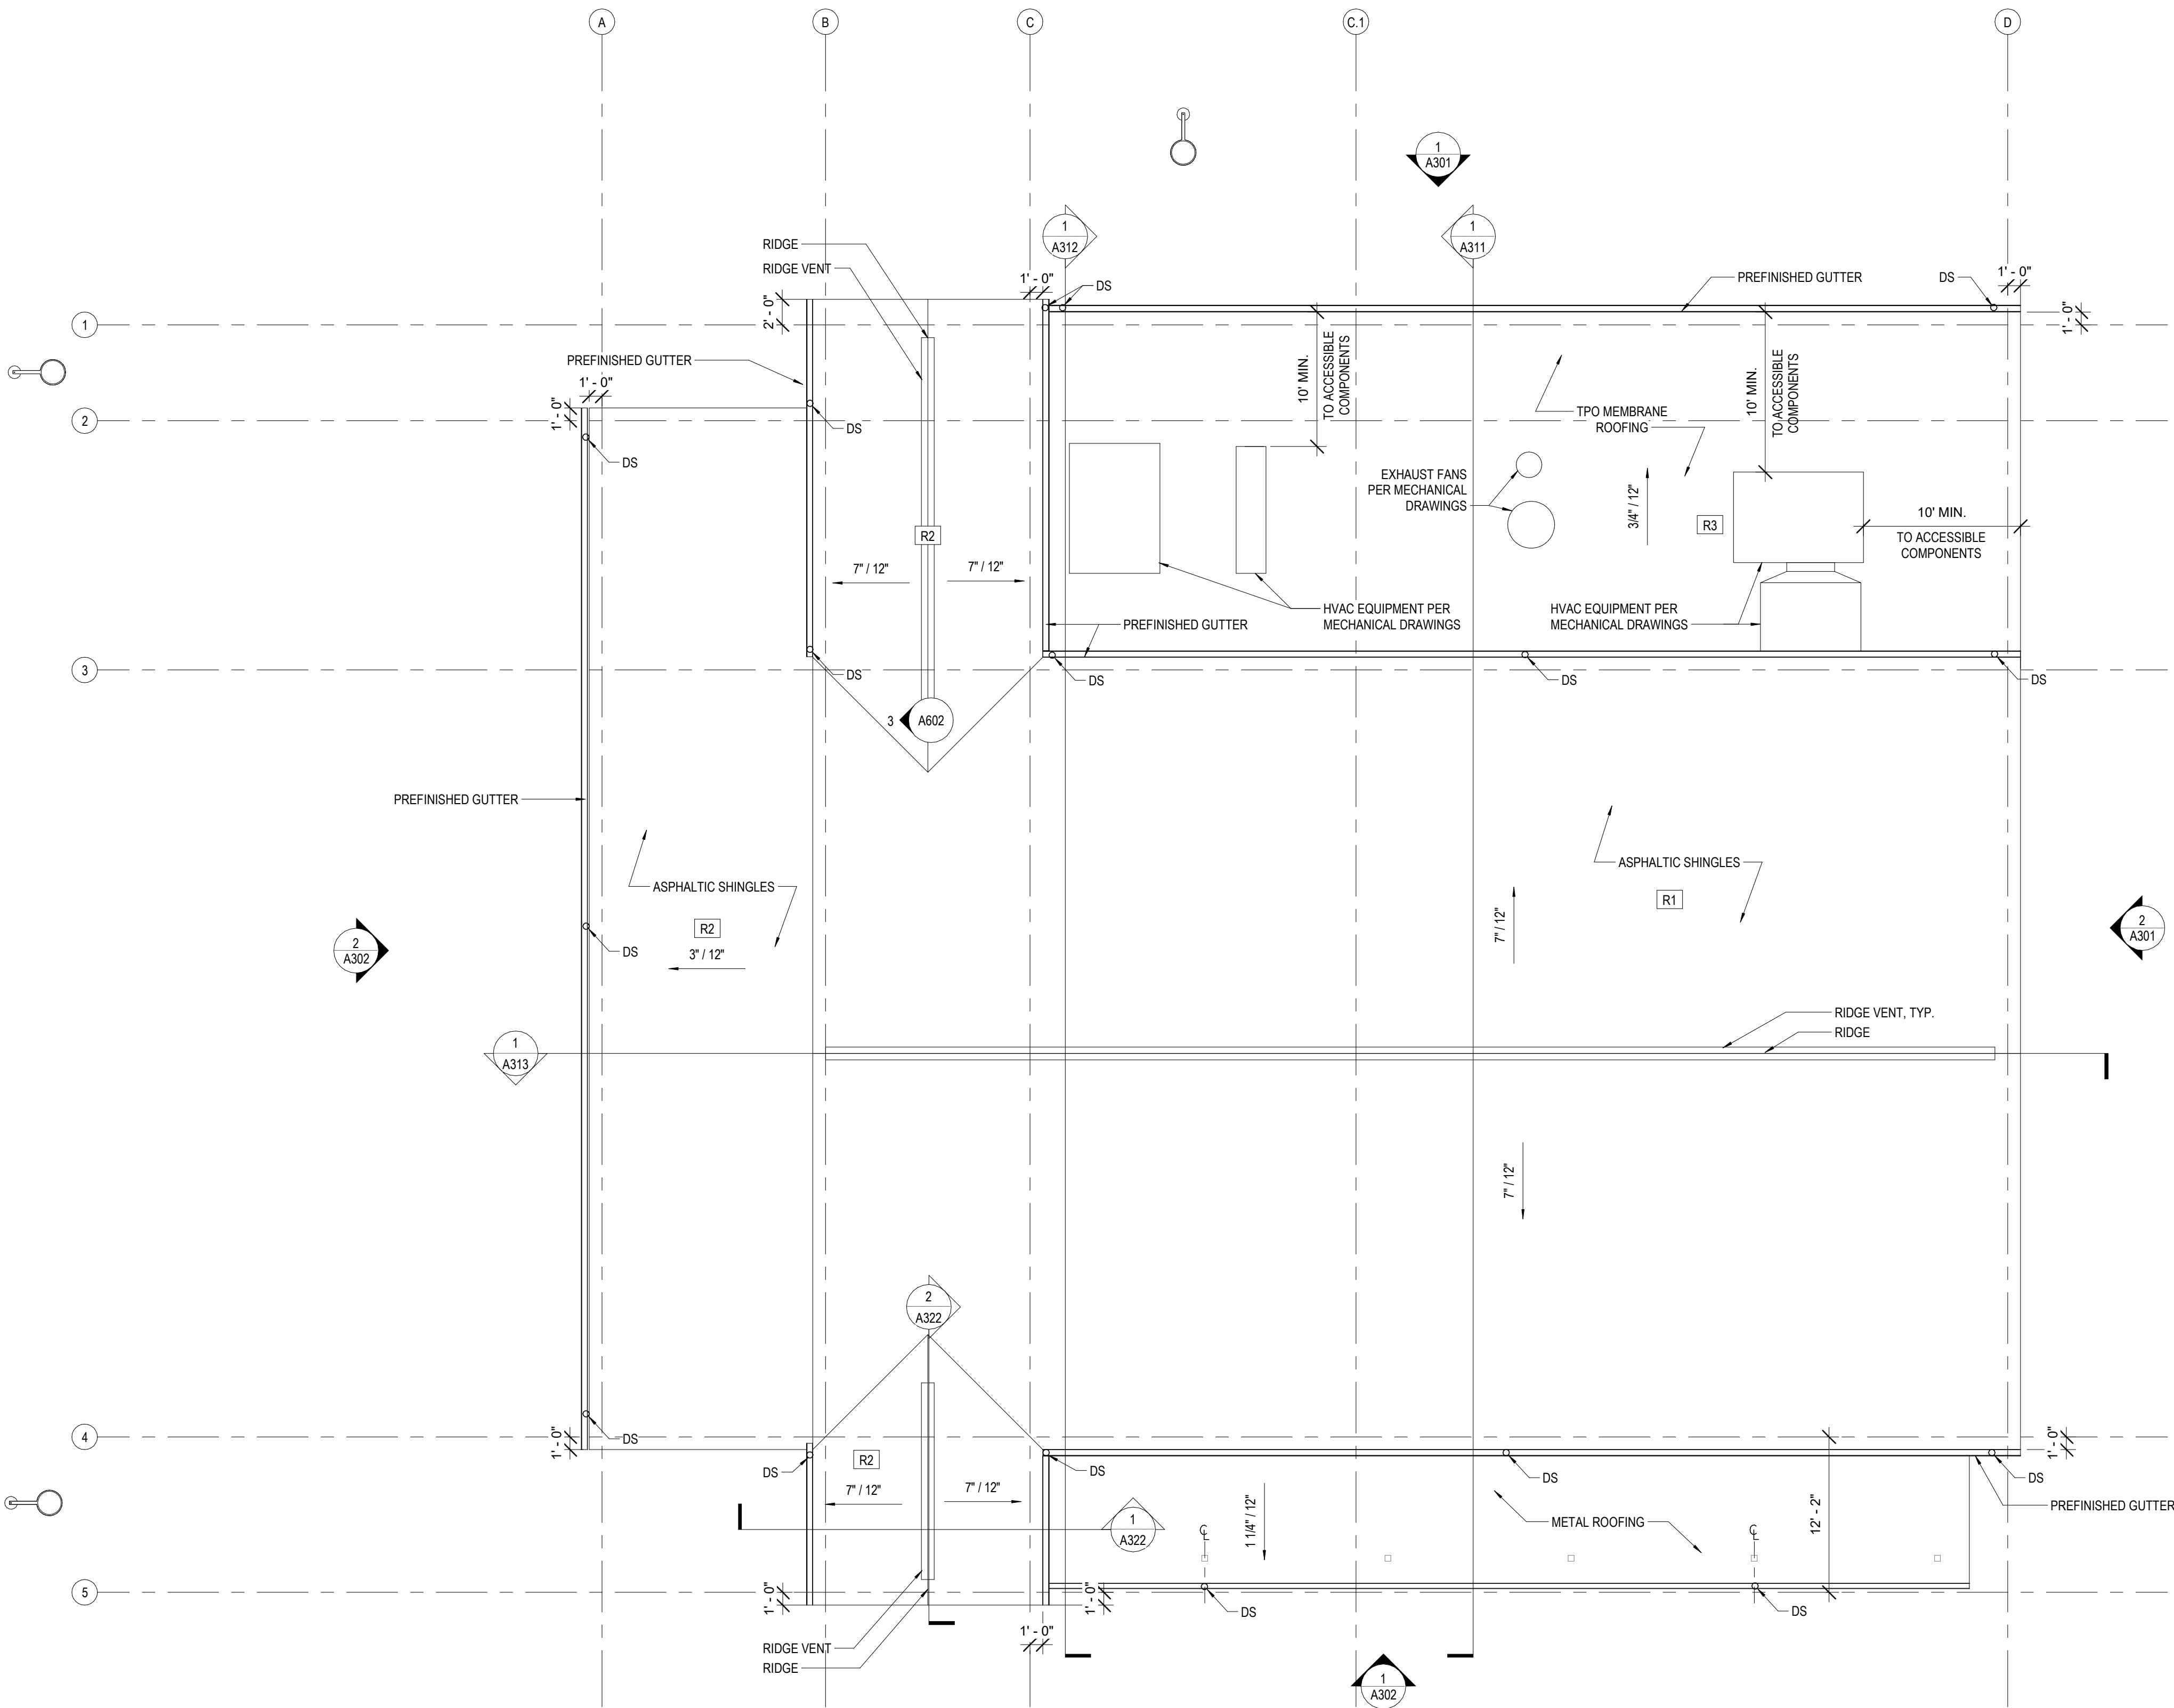

1 Roof Plan
1/8" = 1'-0"
0 2 4 6 8 10

SHEET NOTES

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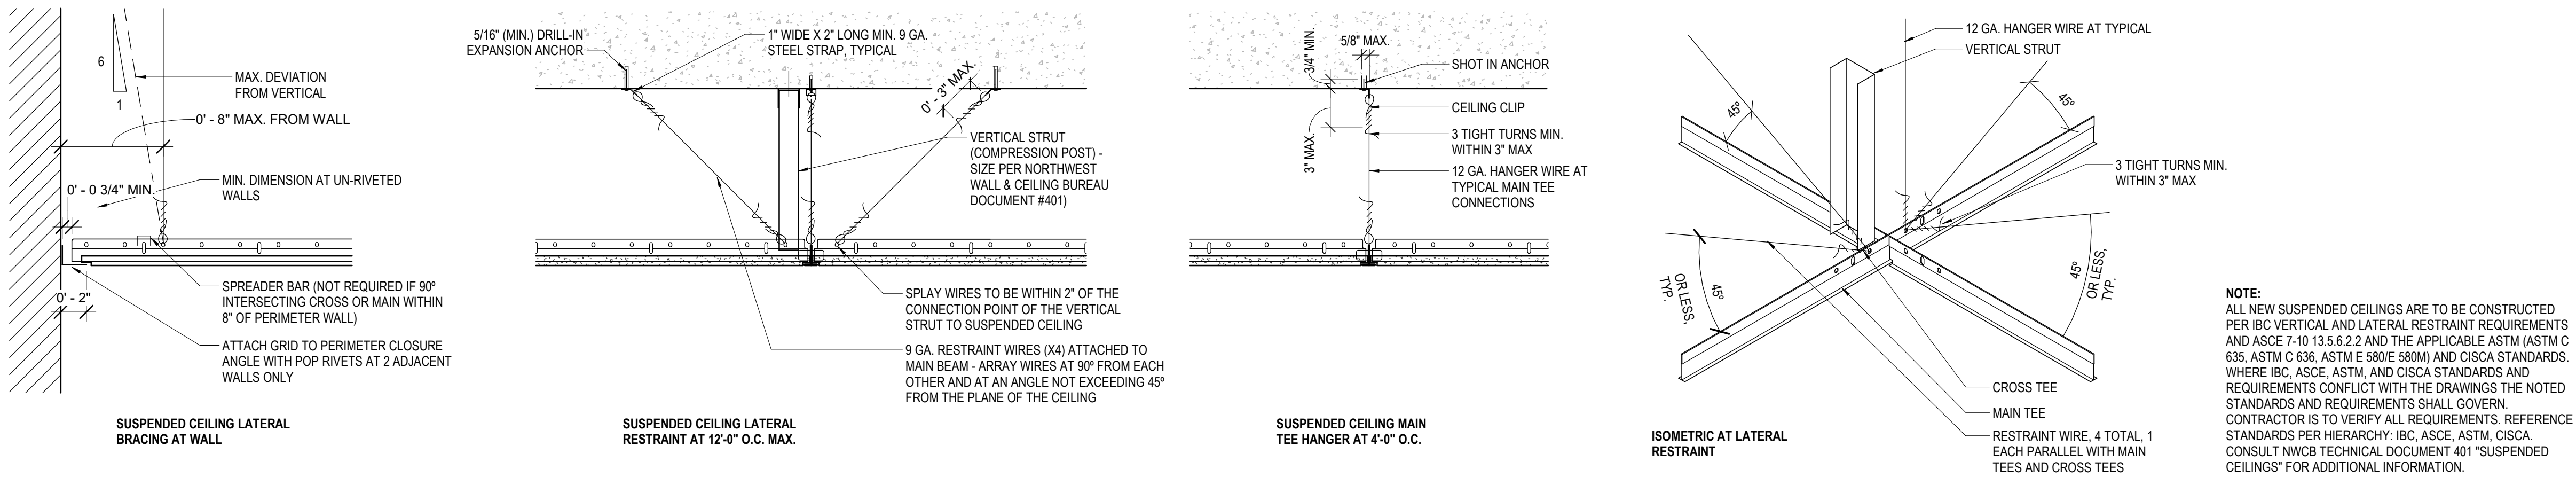


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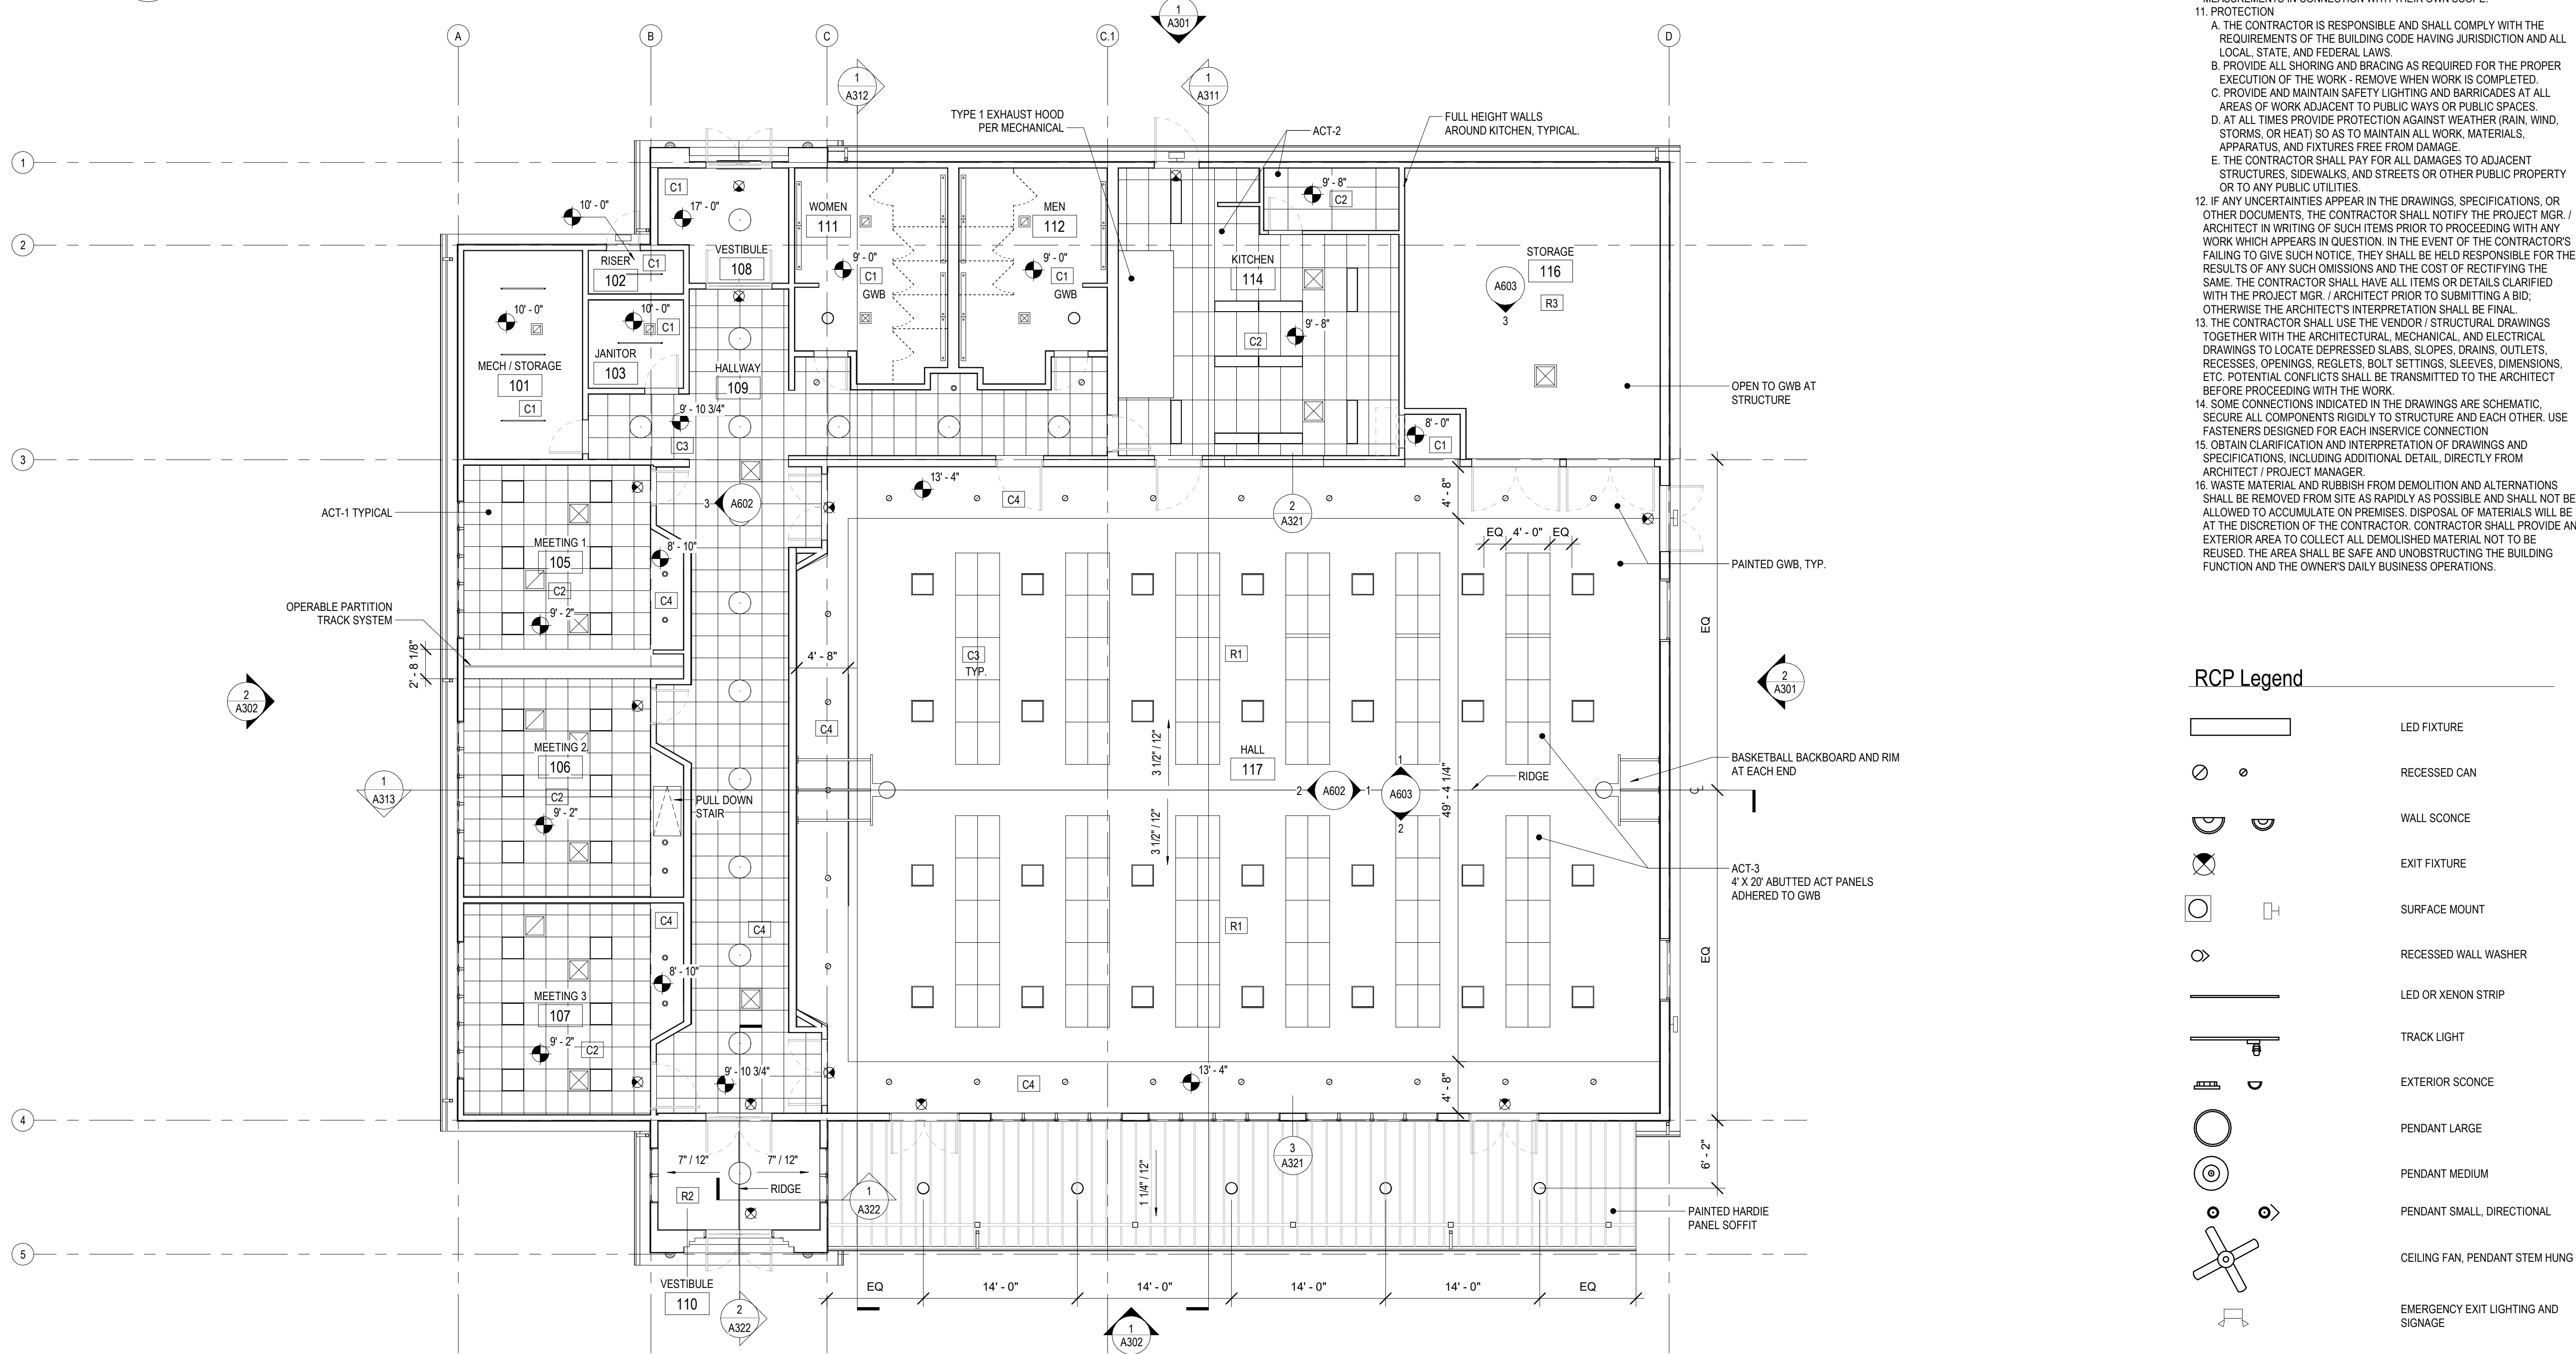
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ROOF PLAN

A202



3 Lateral Support of Suspended Ceiling
1 1/2" = 1'-0"



1 Reflected Ceiling Plan
1/8" = 1'-0"

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RCP Legend

- | | |
|--|-------------------------------------|
| | LED FIXTURE |
| | RECESSED CAN |
| | WALL SCONCE |
| | EXIT FIXTURE |
| | SURFACE MOUNT |
| | RECESSED WALL WASHER |
| | LED OR XENON STRIP |
| | TRACK LIGHT |
| | EXTERIOR SCONCE |
| | PENDANT LARGE |
| | PENDANT MEDIUM |
| | PENDANT SMALL, DIRECTIONAL |
| | CEILING FAN, PENDANT STEM HUNG |
| | EMERGENCY EXIT LIGHTING AND SIGNAGE |

RMC ARCHITECTS

6979 REGISTERED ARCHITECT
BRADLEY P. CORNWELL
STATE OF WASHINGTON

Archdiocese of Seattle
St. Andrew Catholic Church Parish Hall
1401 Valley Avenue East
Sumner, WA 98390-2720

Job No.: 1851 Date: 2020-02-07
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REFLECTED
CEILING PLAN

A210

1. DIMENSIONS SHOWN ARE FROM FACE OF STRUCTURE. TYPICAL, UNLESS NOTED OTHERWISE. SEE ASSEMBLIES FOR ADDITIONAL INFORMATION.
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Archdiocese of Seattle

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St. Andrew Catholic
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A301



1/4" = 1'-0"



1/2" = 1'-0"




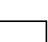



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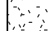
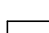

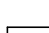
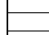
1/8" = 1'-0"



$1/8" = 1'-0"$

- | | |
|---|--|
|  | STUCCO, WITH CONTROL JOINTS PER ELEVATION |
|  | SMOOTH HARDIE PANELING WITH CONTROL JOINTS PER ELEVATION |
|  | COMPOSITE LAP SIDING |
|  | COMPOSITE BOARD AND BATTEN SIDING |
|  | BRICK VENEER |

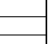


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BUILDING
SECTIONS

A311




1 N-S Section 1
1/4" = 1'-0"

Archdiocese of Seattle
St. Andrew Catholic Church Parish Hall
1401 Valley Avenue East
Sumner, WA 98390-2720

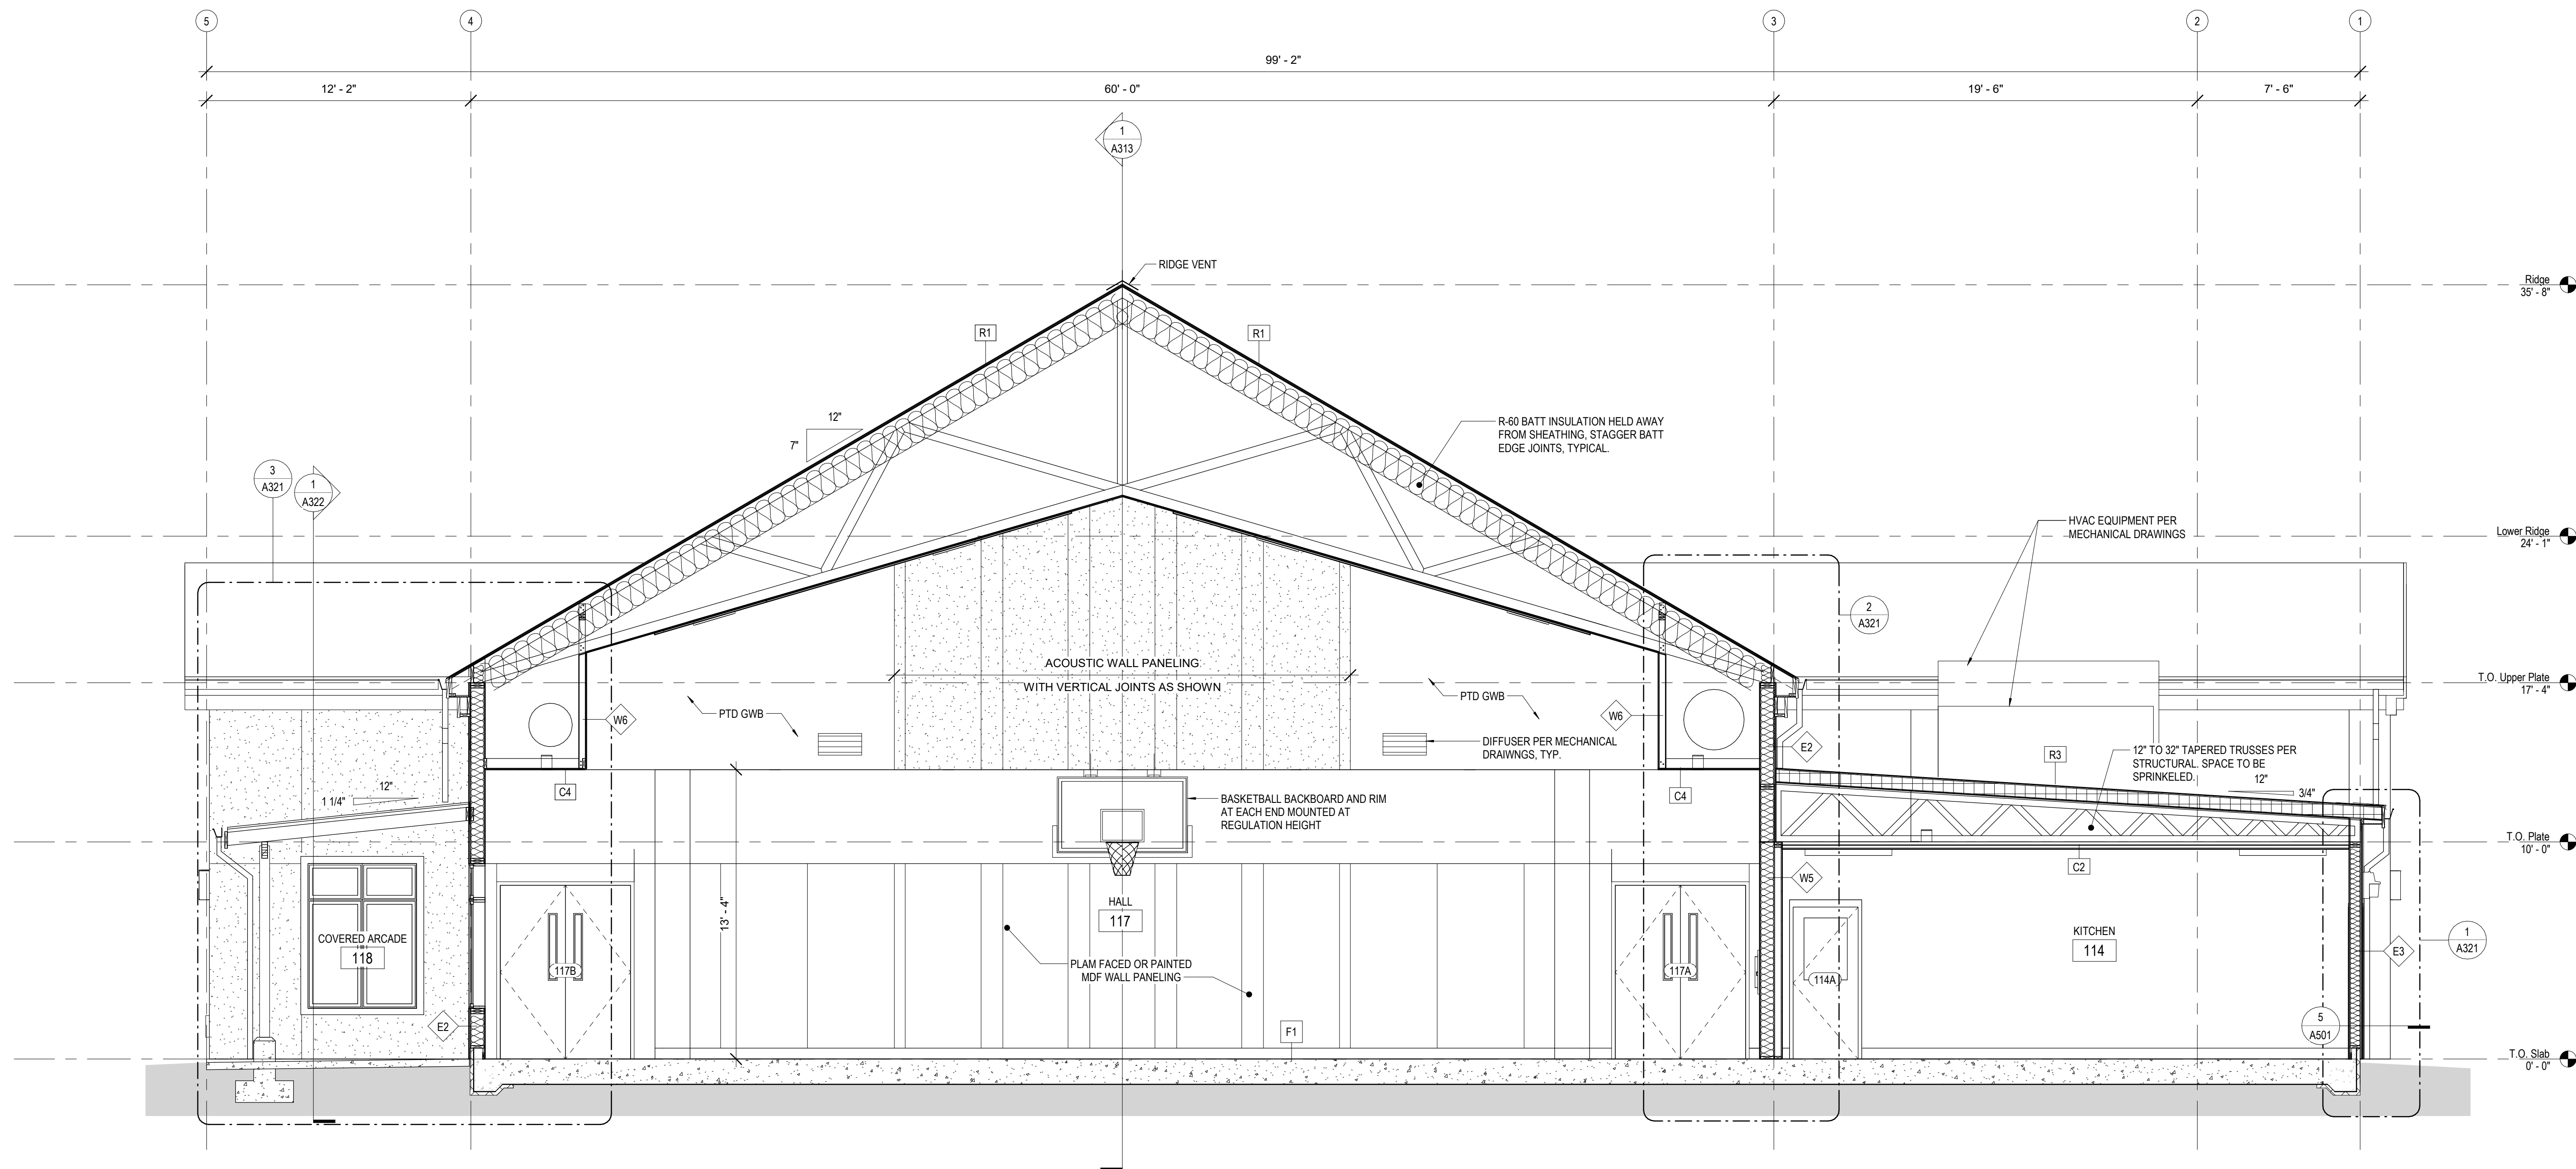Job No.: 1851 Date: 2020-02-07
File No.: 1851 St. Andrew Parish Hall
Drawn By: AMR
Checked By: BPC
Issued for: PERMIT SET

BUILDING
SECTIONS

A312

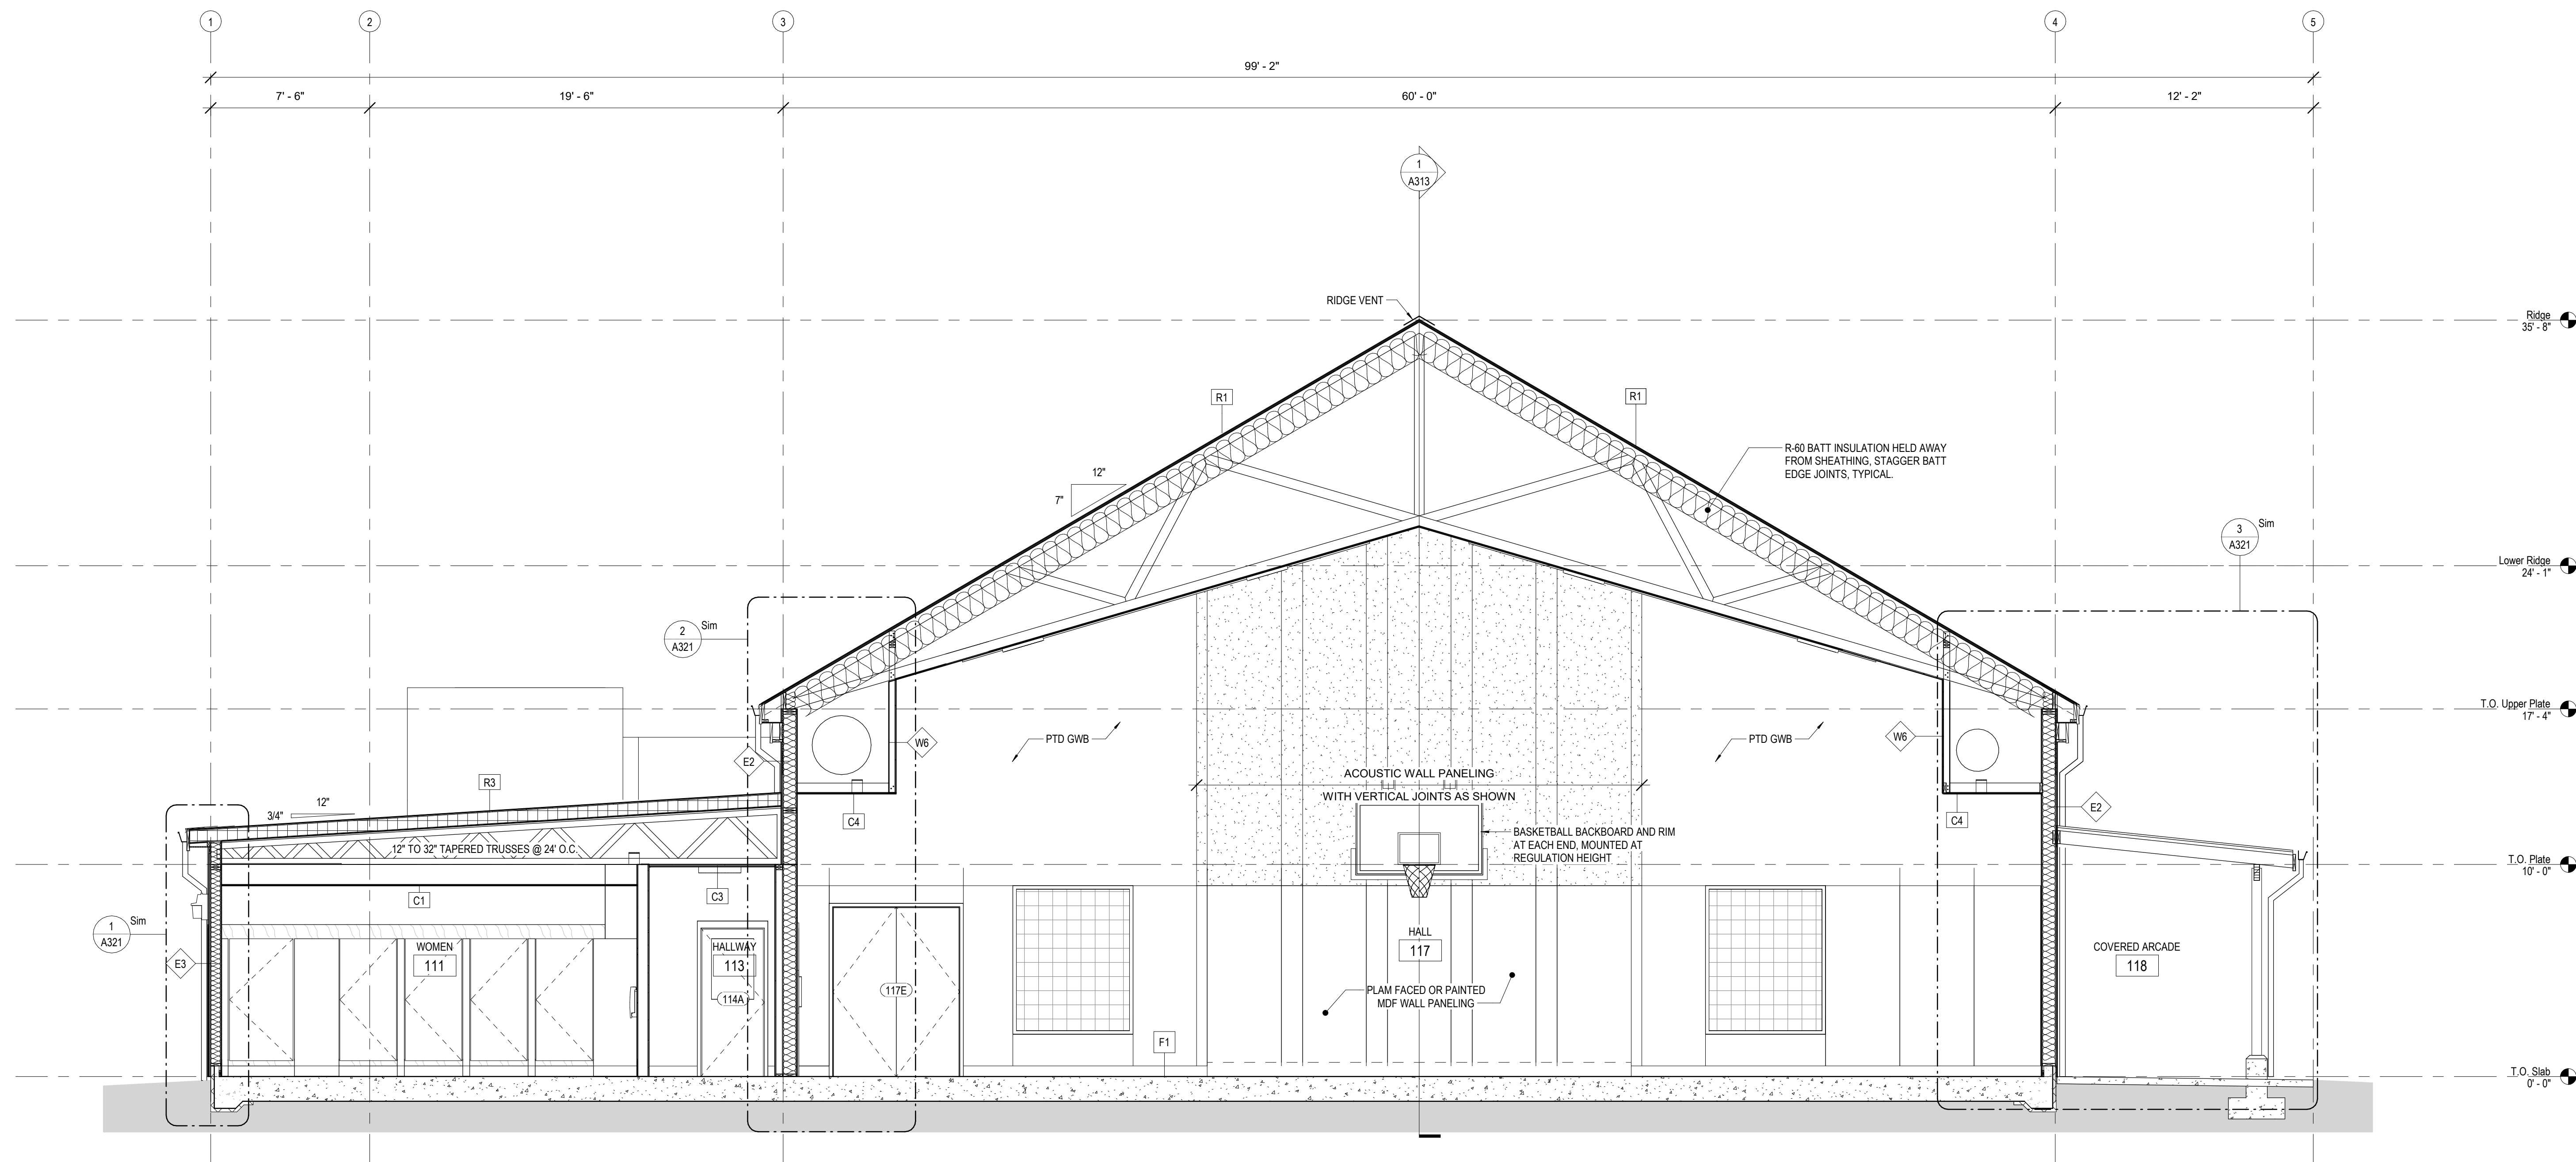

1 N-S Section 2
1/4" = 1'-0"
0 1' 2' 3'

Archdiocese of Seattle
St. Andrew Catholic Church Parish Hall
1401 Valley Avenue East
Sumner, WA 98390-2720

Job No.: 1851 Date: 2020-02-07
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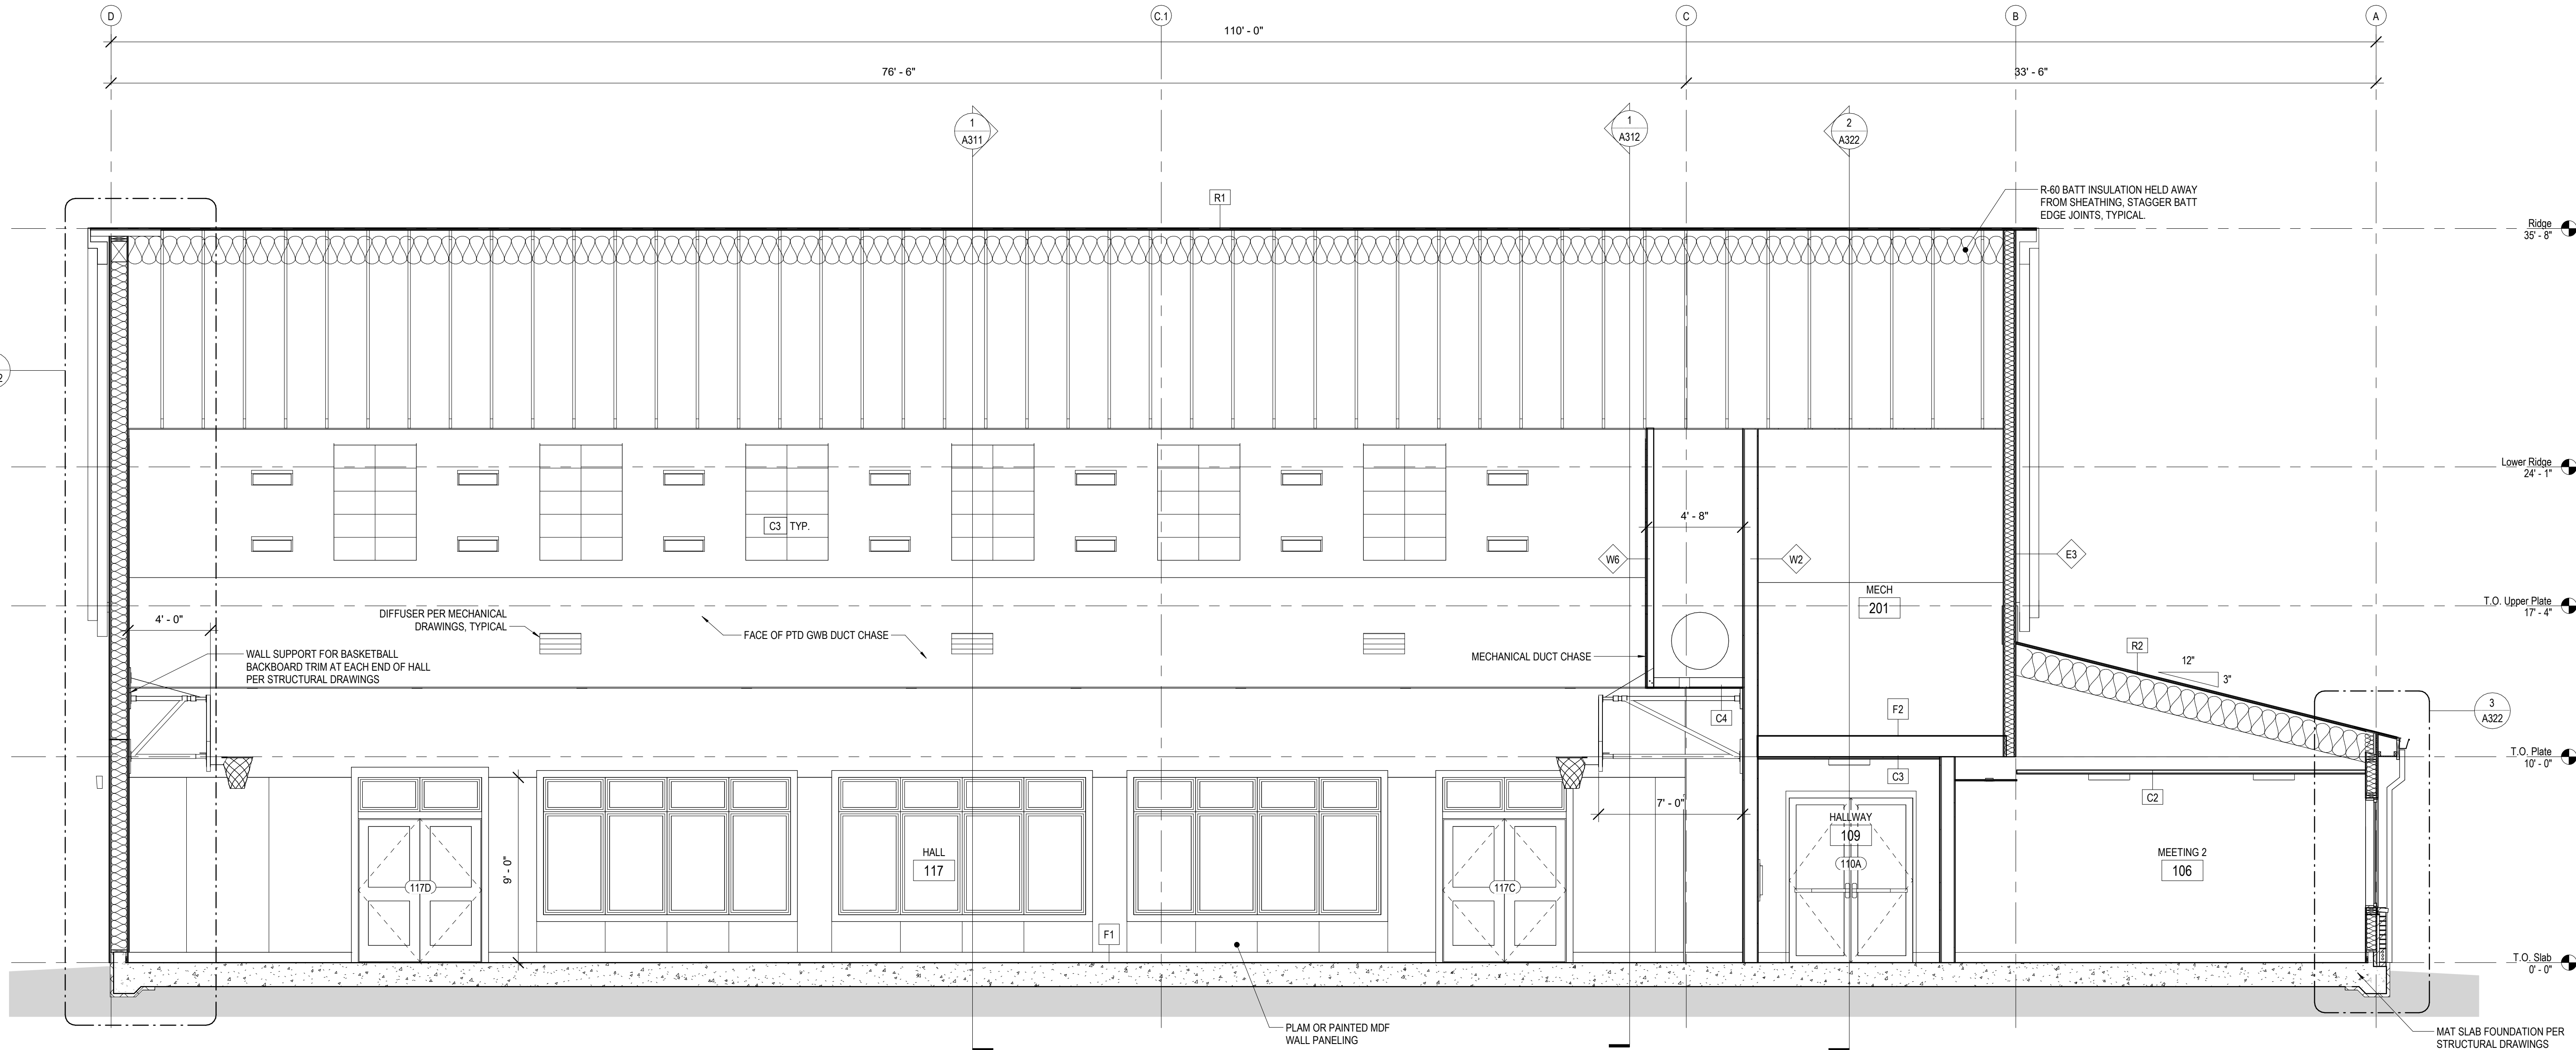
BUILDING
SECTIONS


A313

1


E-W Section 1

1/4" = 1'-0"




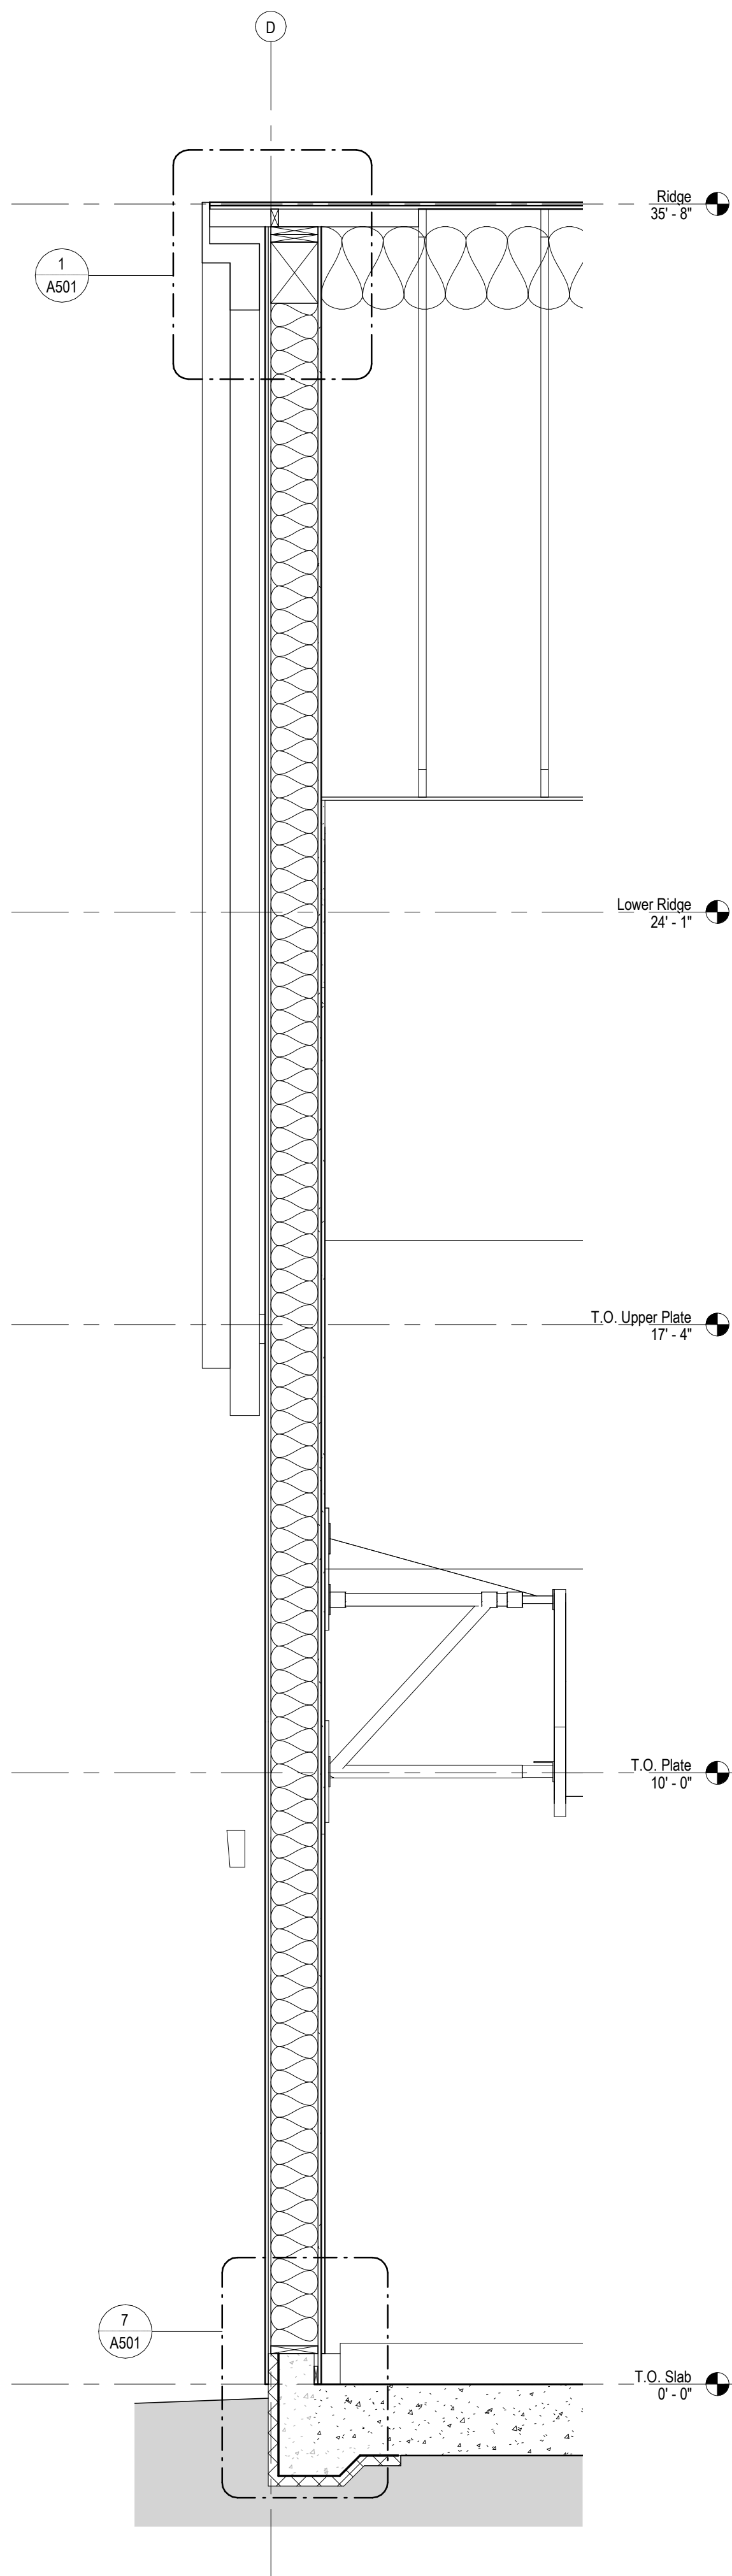


4 E-W Wall Section
1/2" = 1'-0"

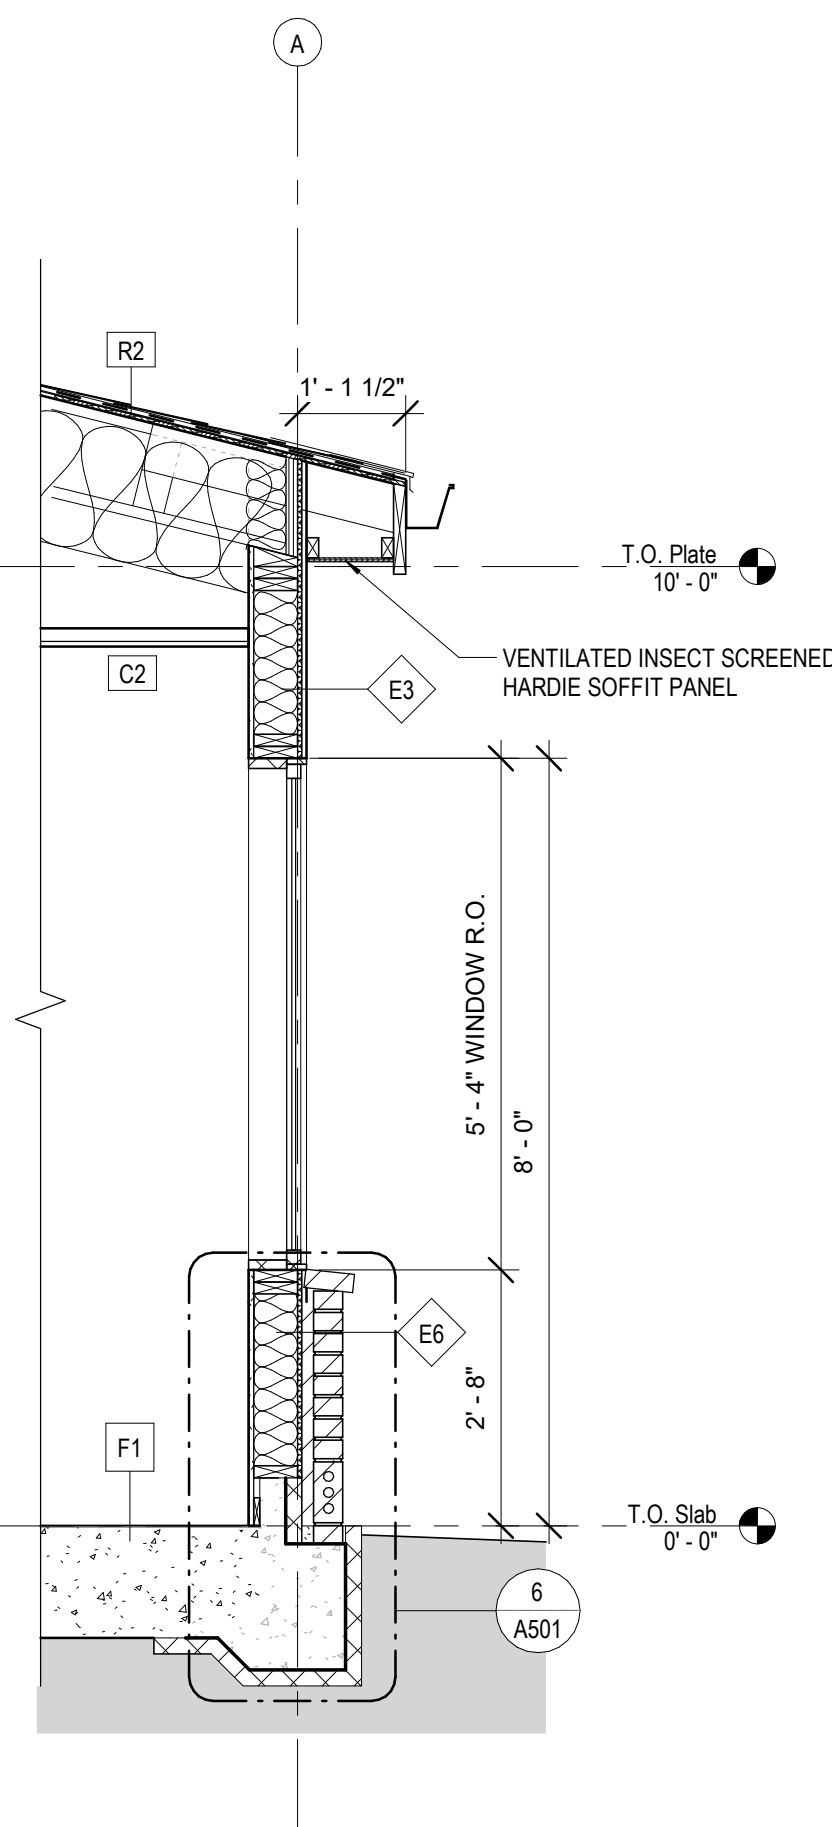

3 Wall Section at West
1/2" = 1'-0"

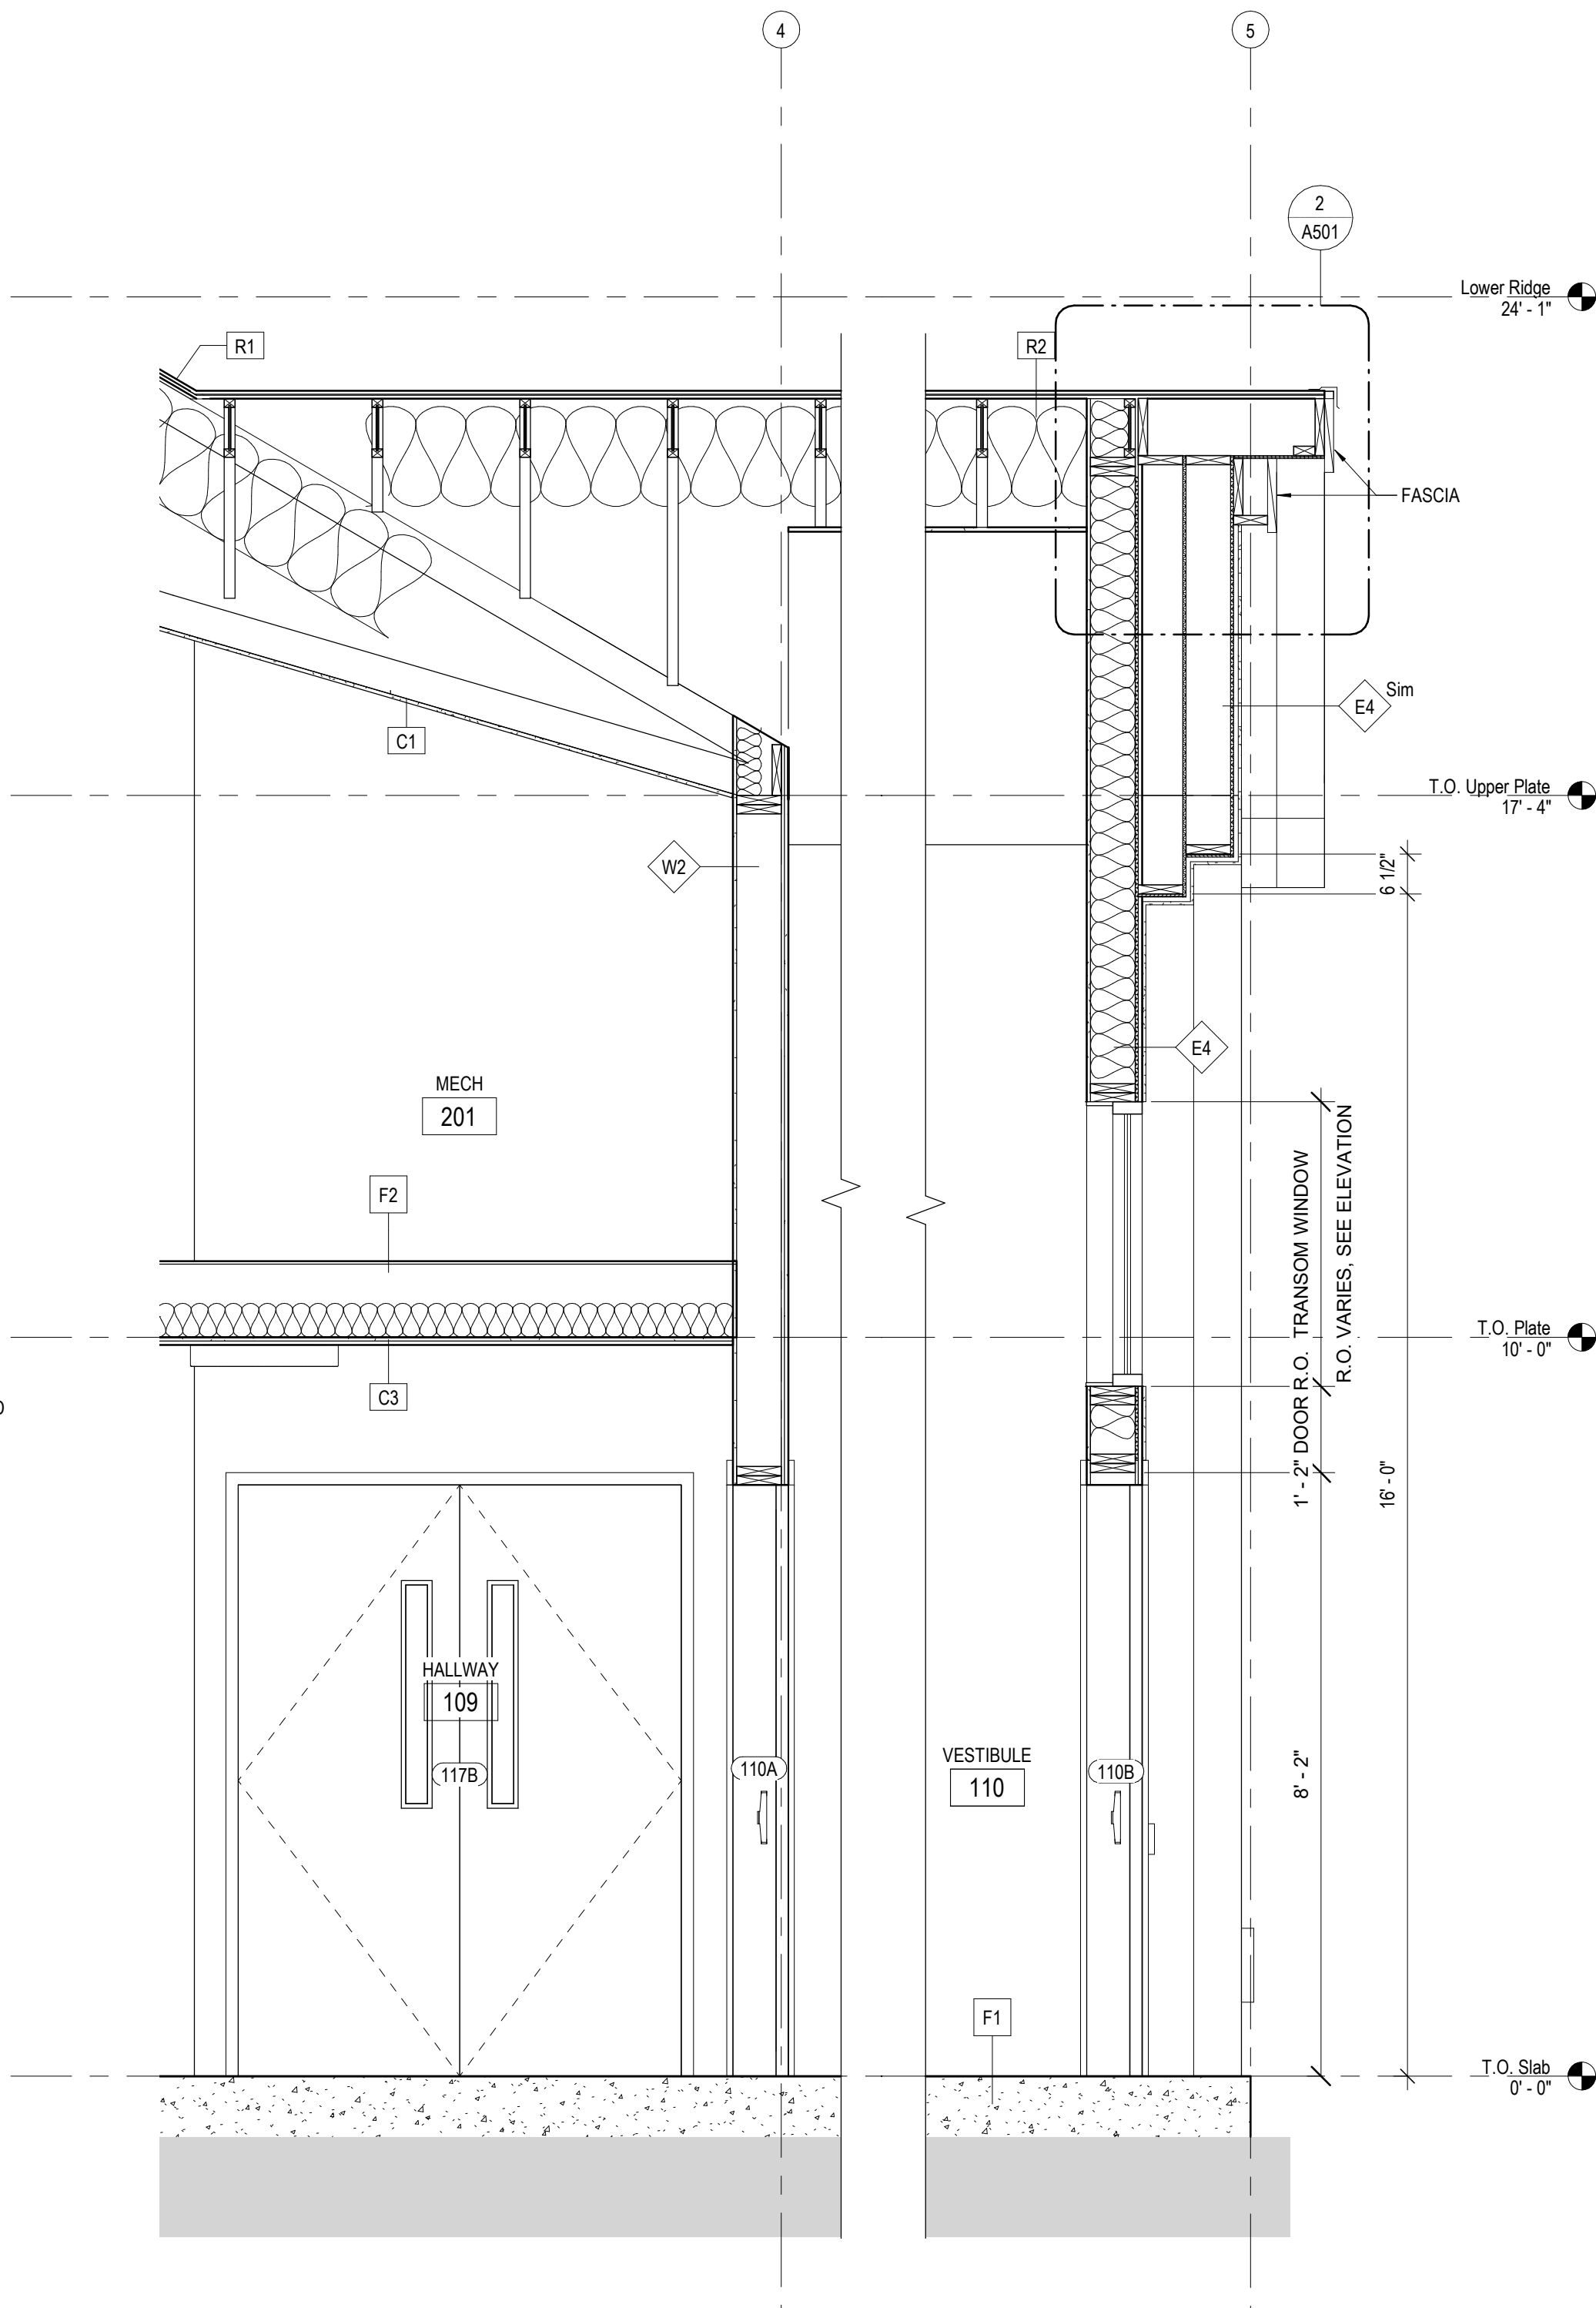

2 N-S Section through Entry Vestibule
1/2" = 1'-0"

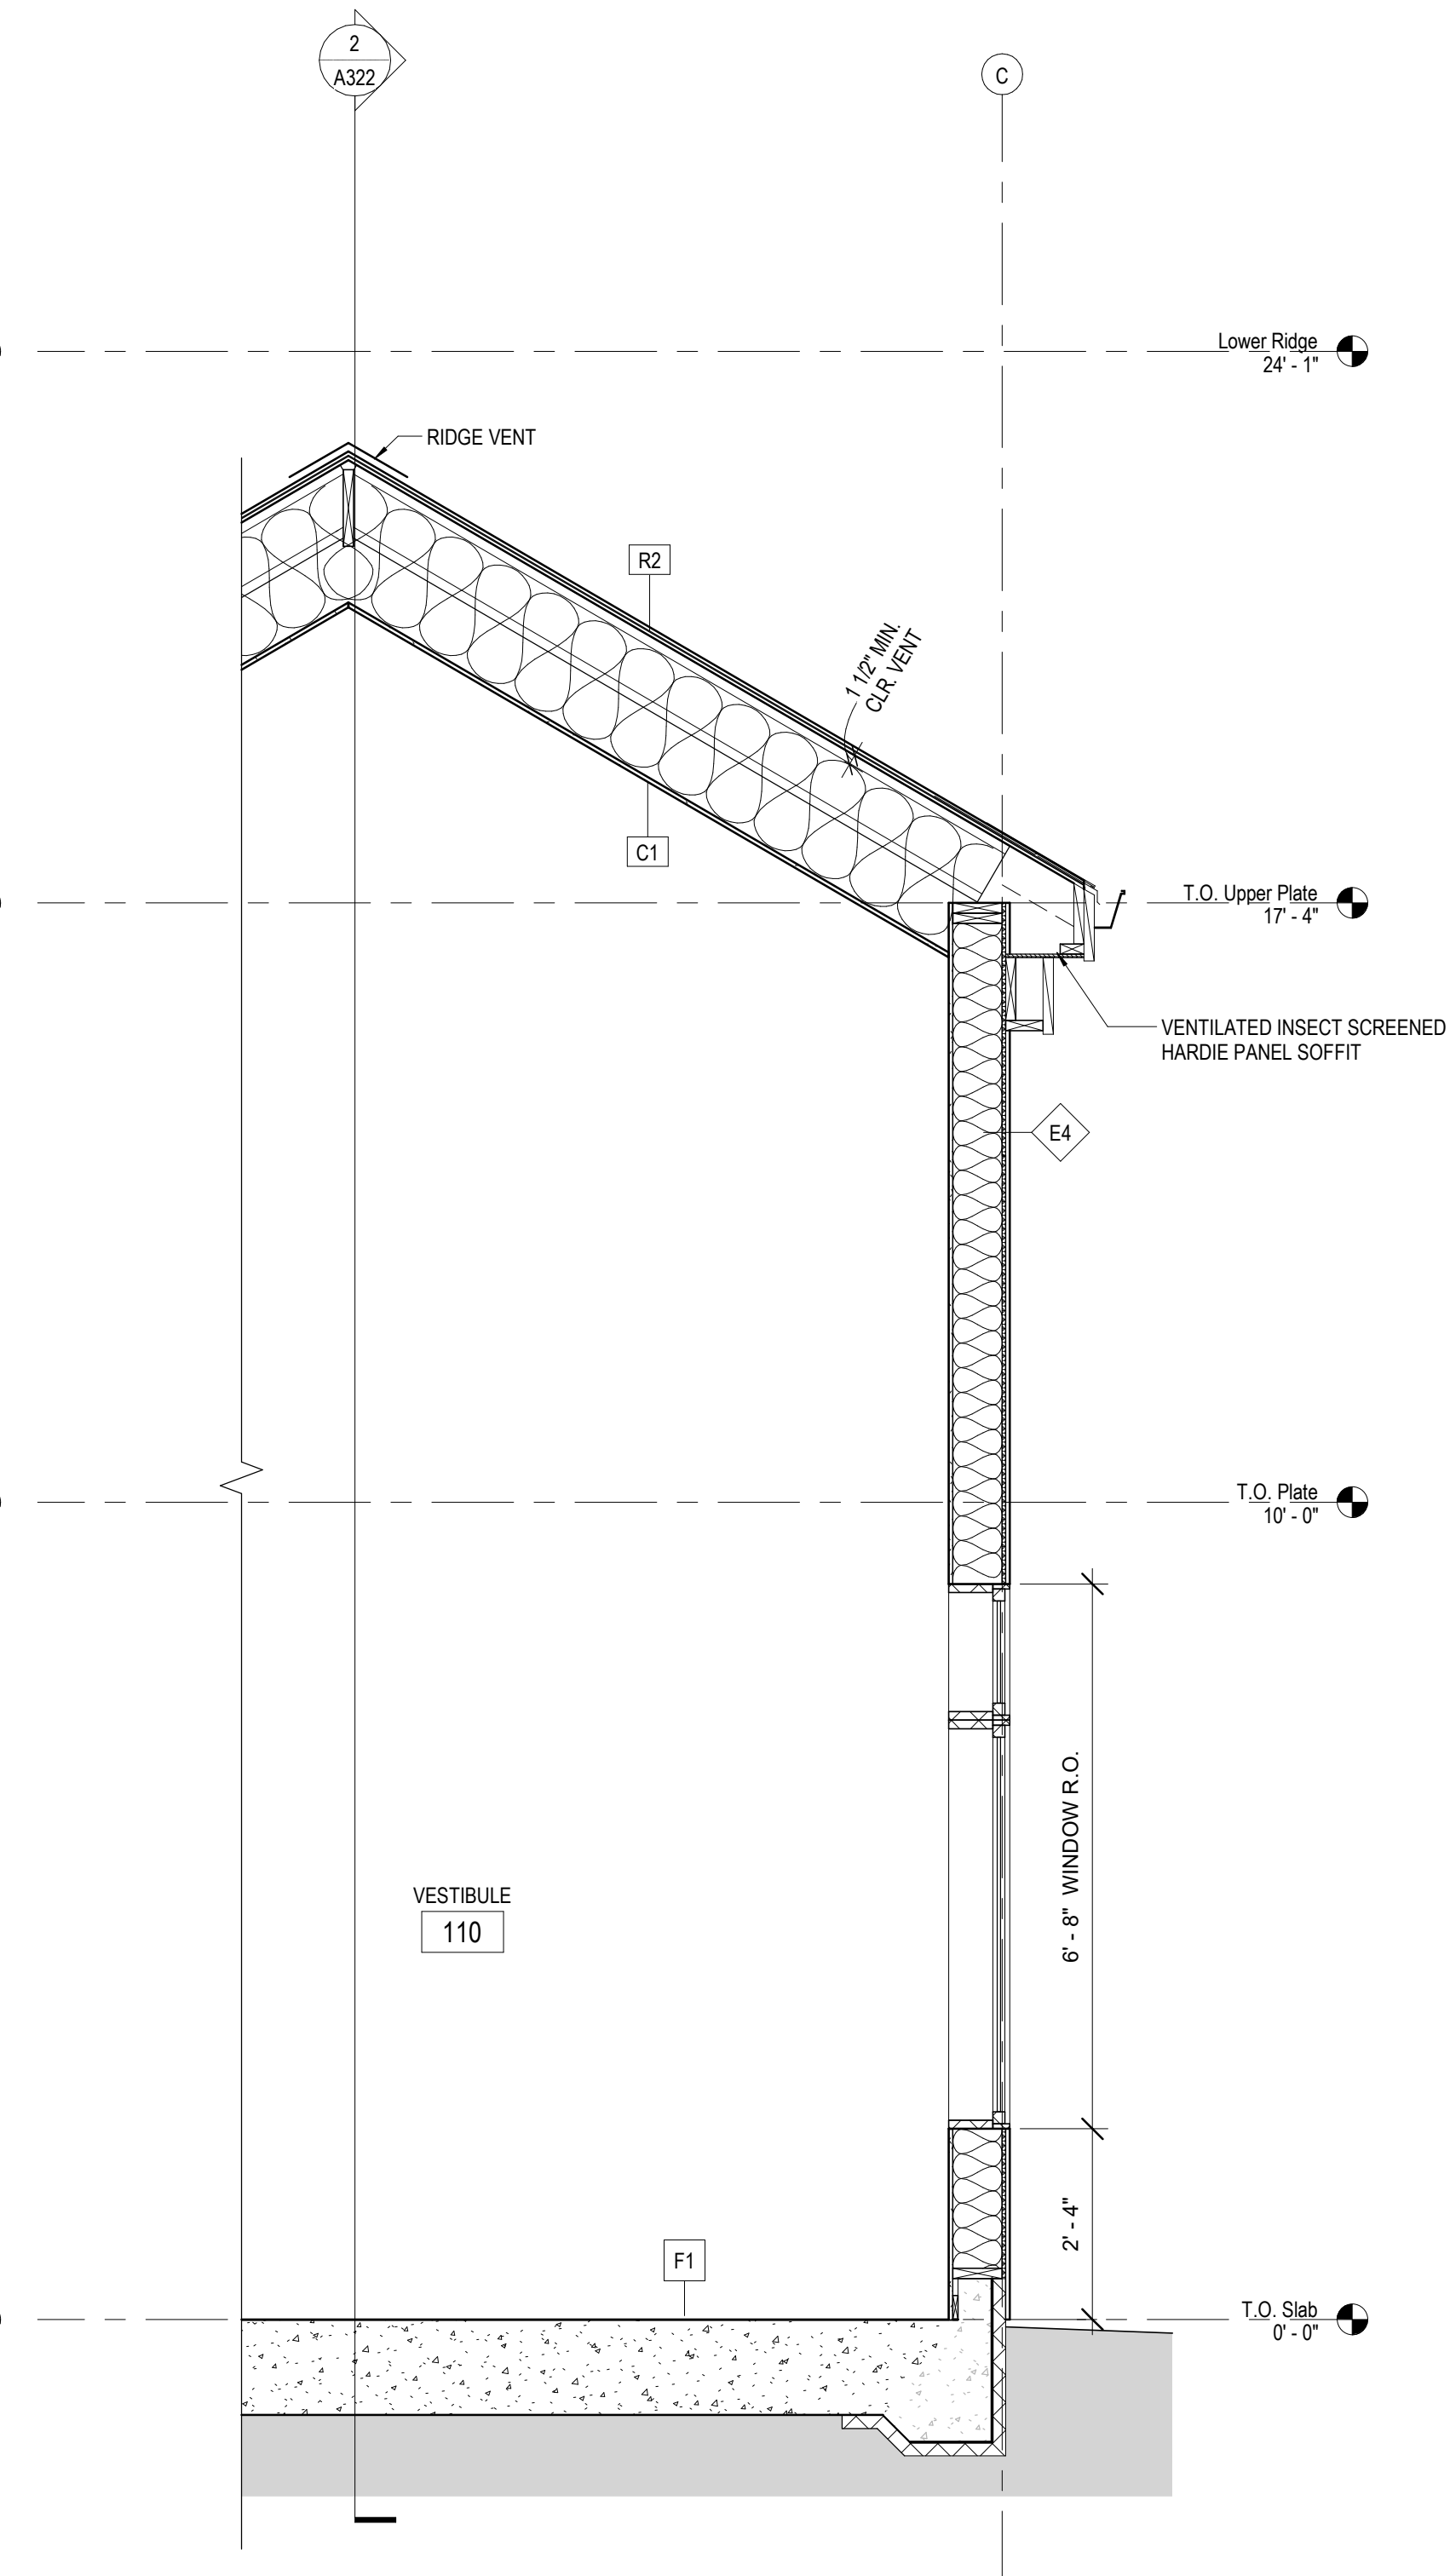


1 E-W Section through Entry Vestibule
1/2" = 1'-0"

Archdiocese of Seattle
St. Andrew Catholic Church Parish Hall
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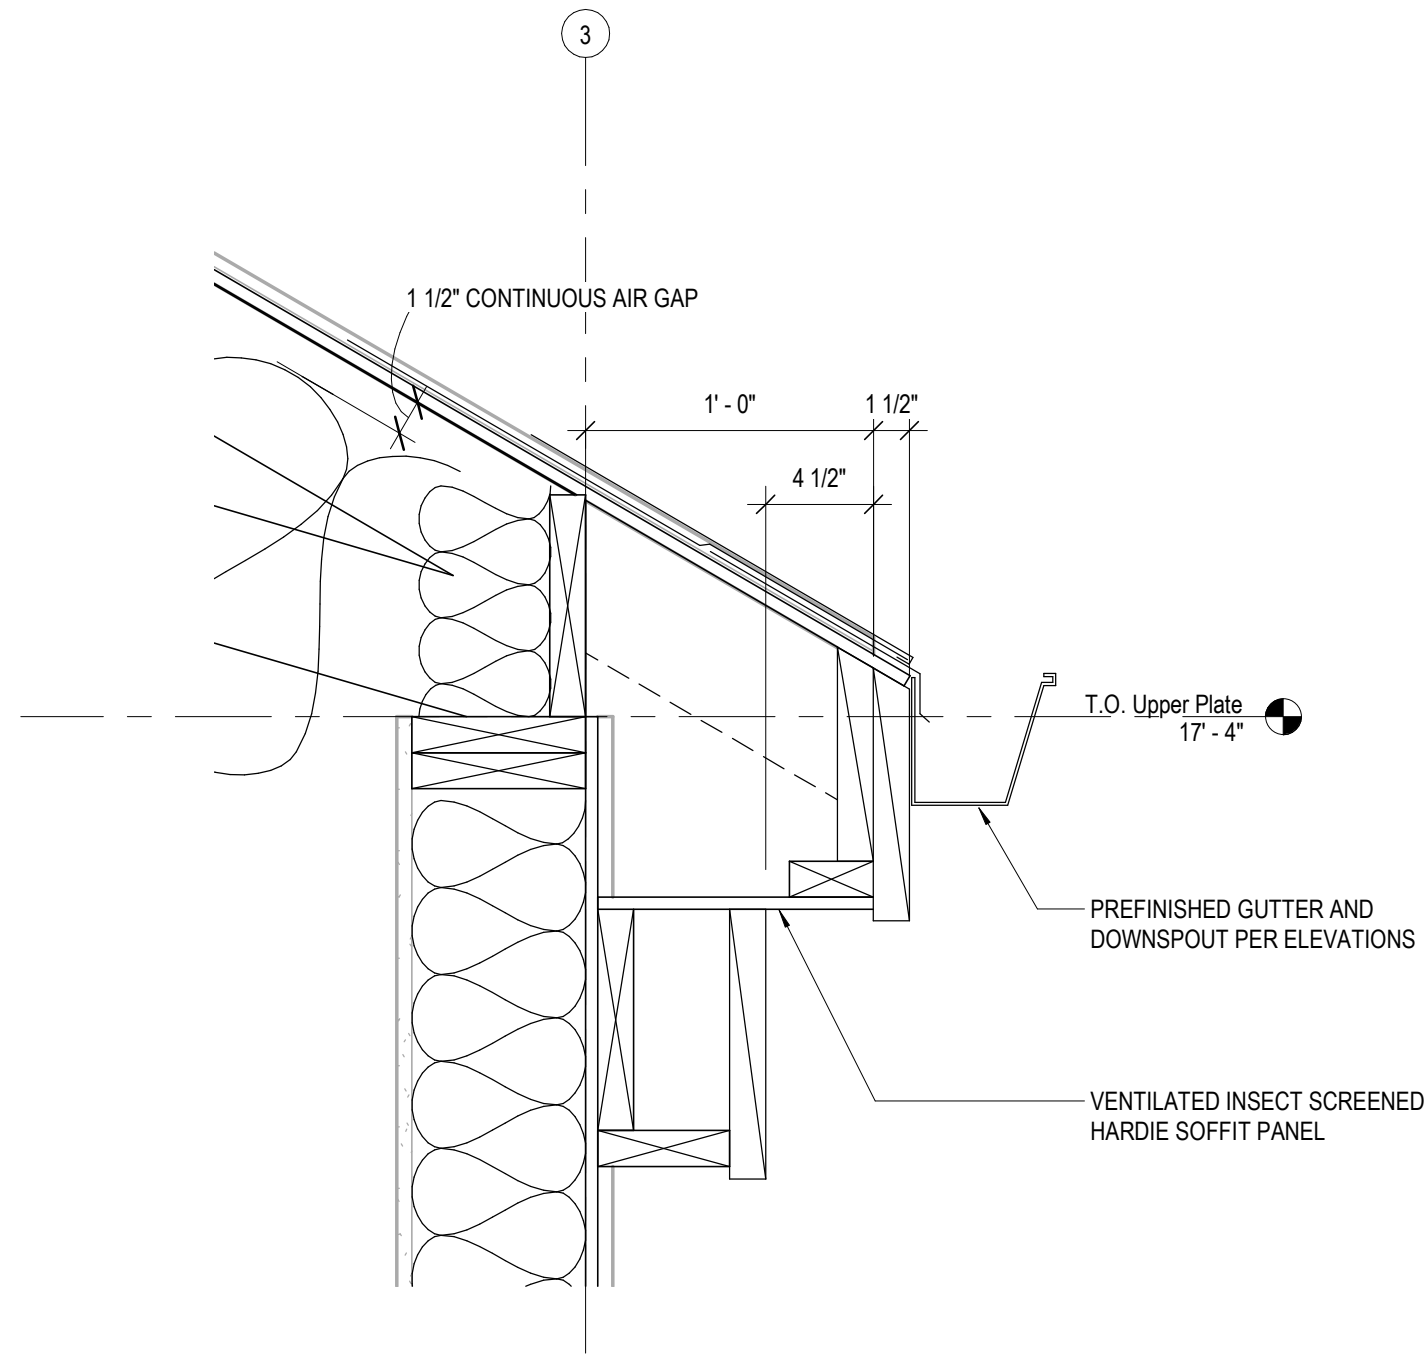
Job No.: 1851 Date: 2020-02-07
File No.: 1851 St. Andrew Parish Hall
Drawn By: AMR
Checked By: BPC
Issued for: PERMIT SET

WALL SECTIONS


A322

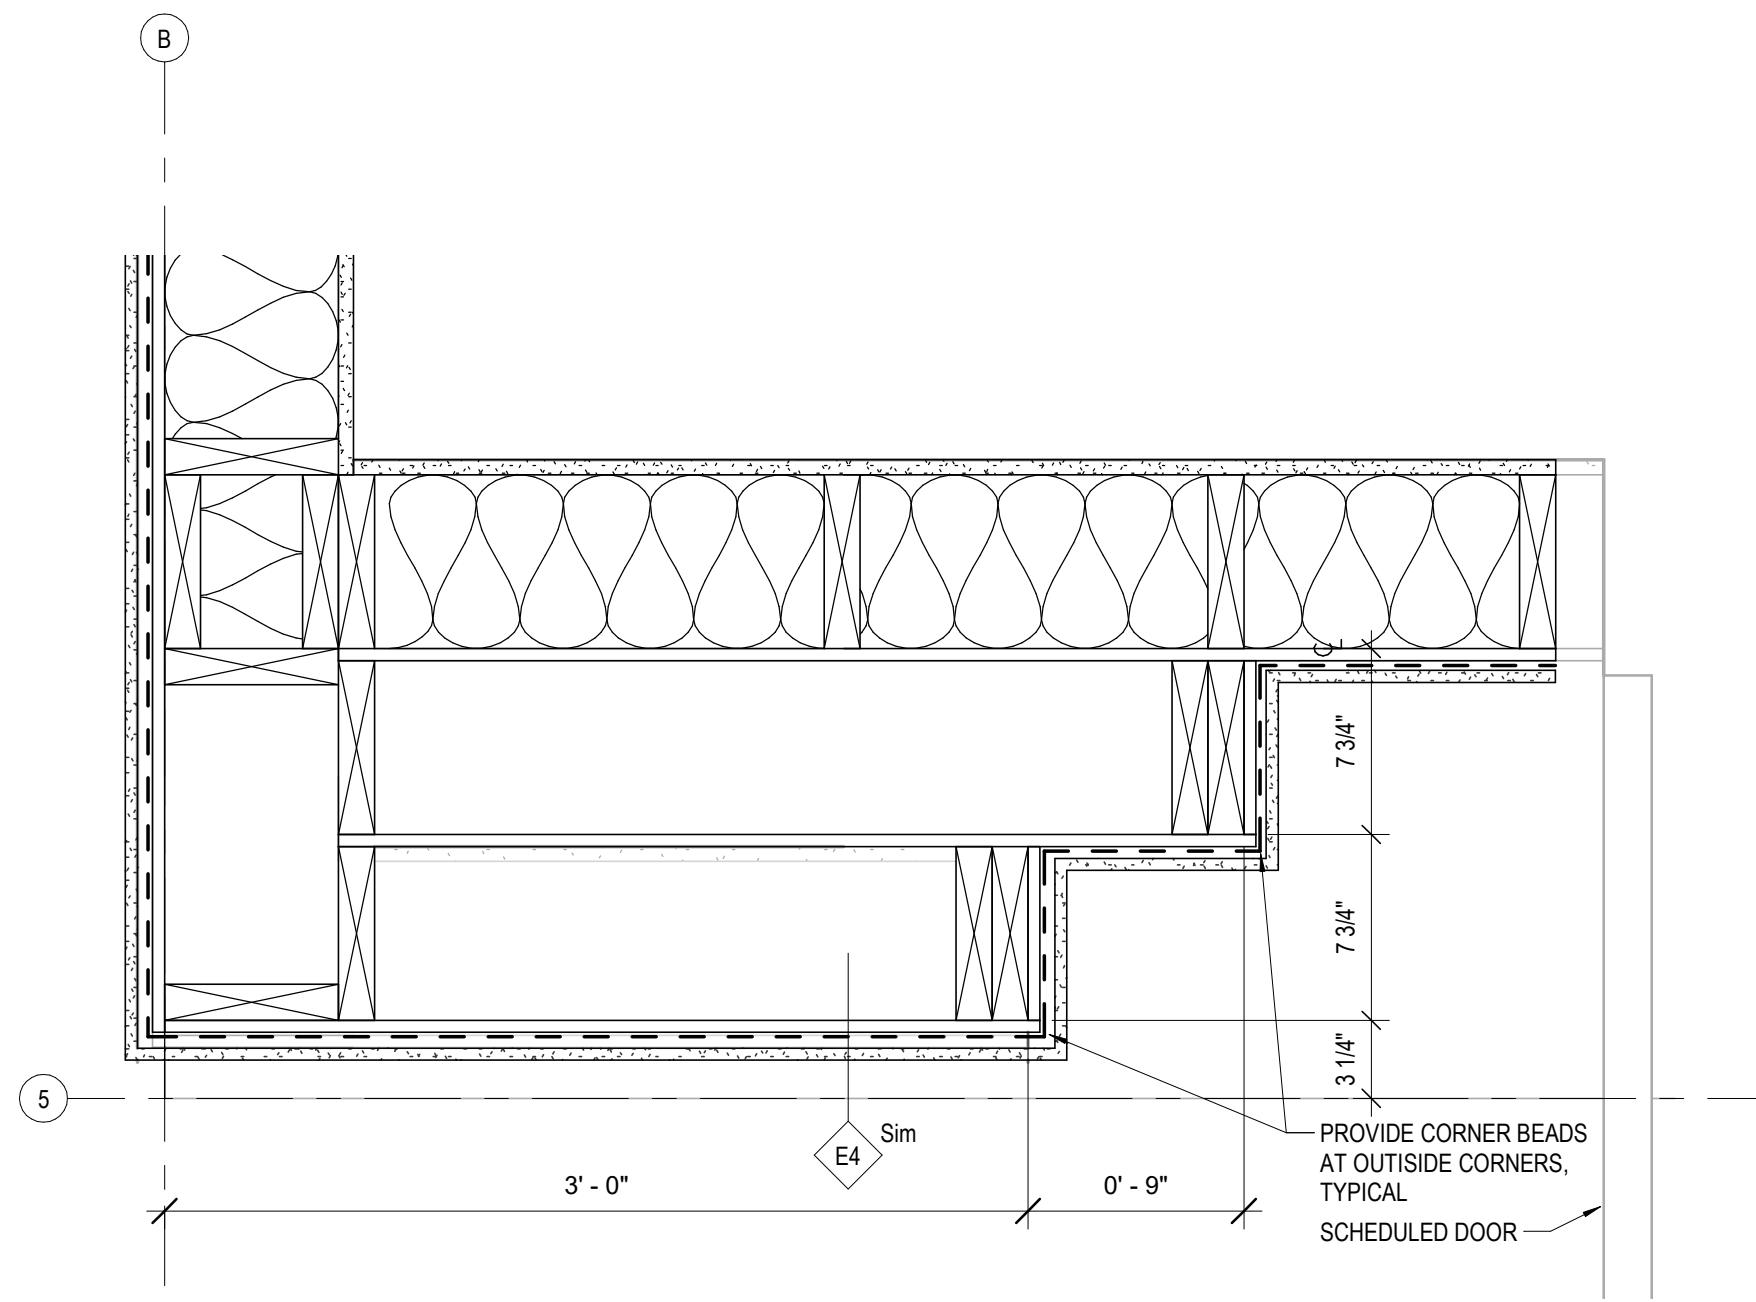


5 Entry Facade Detail - South
1 1/2" = 1'-0"




6 Eave Detail
1 1/2" = 1'-0"

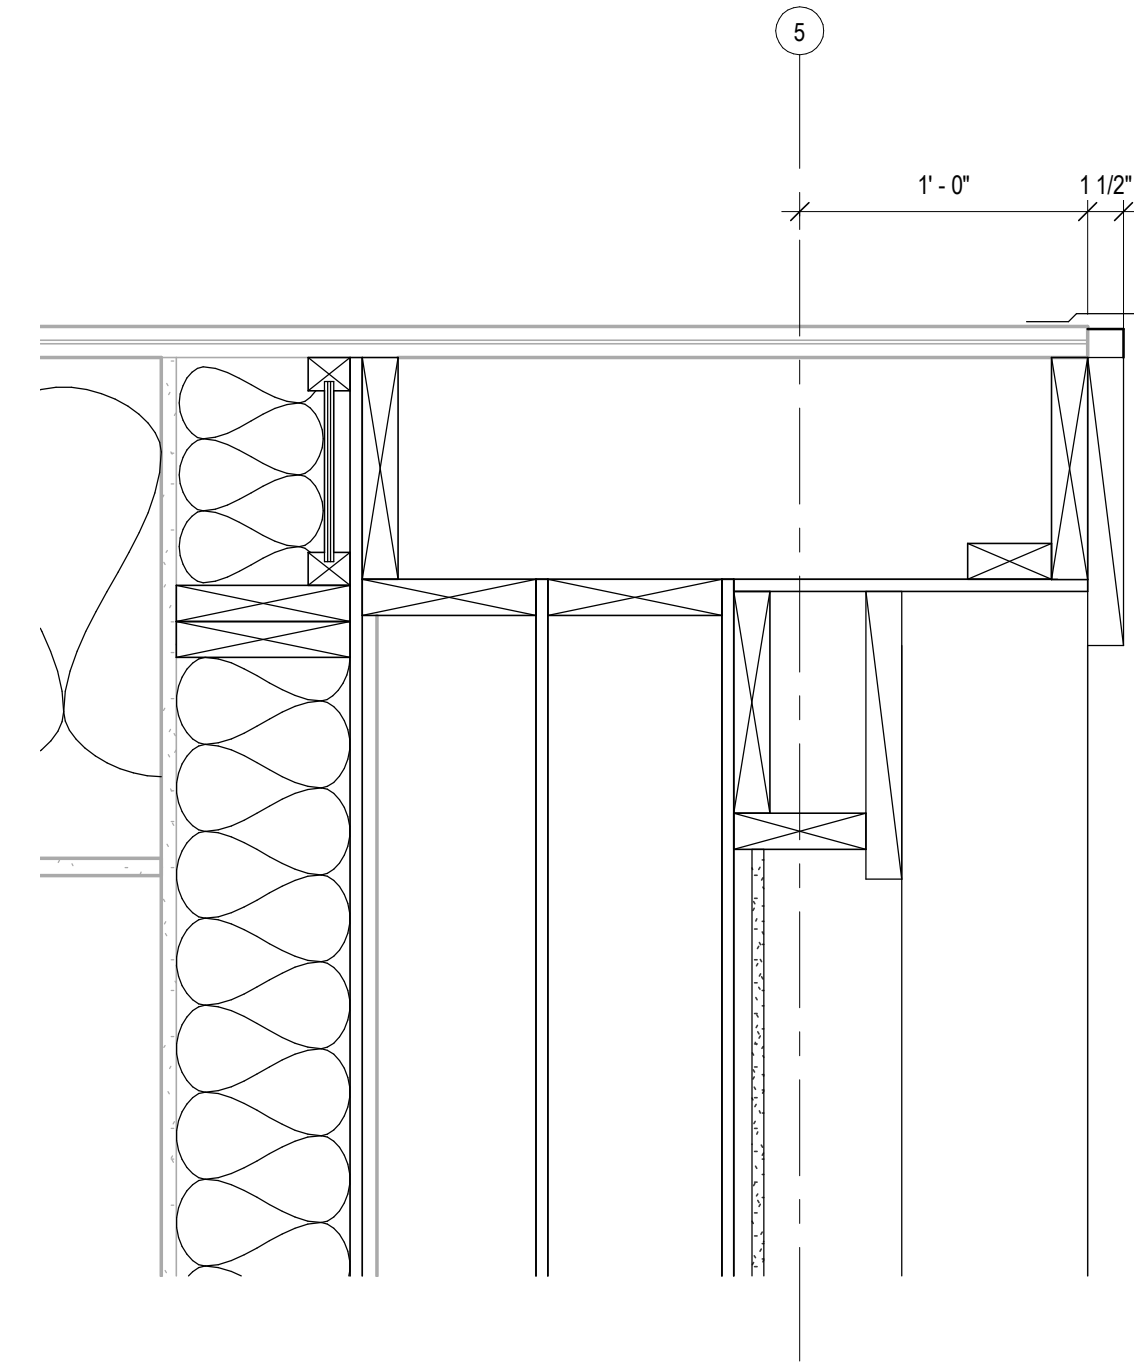


7 Entry Fascia Detail
1 1/2" = 1'-0"

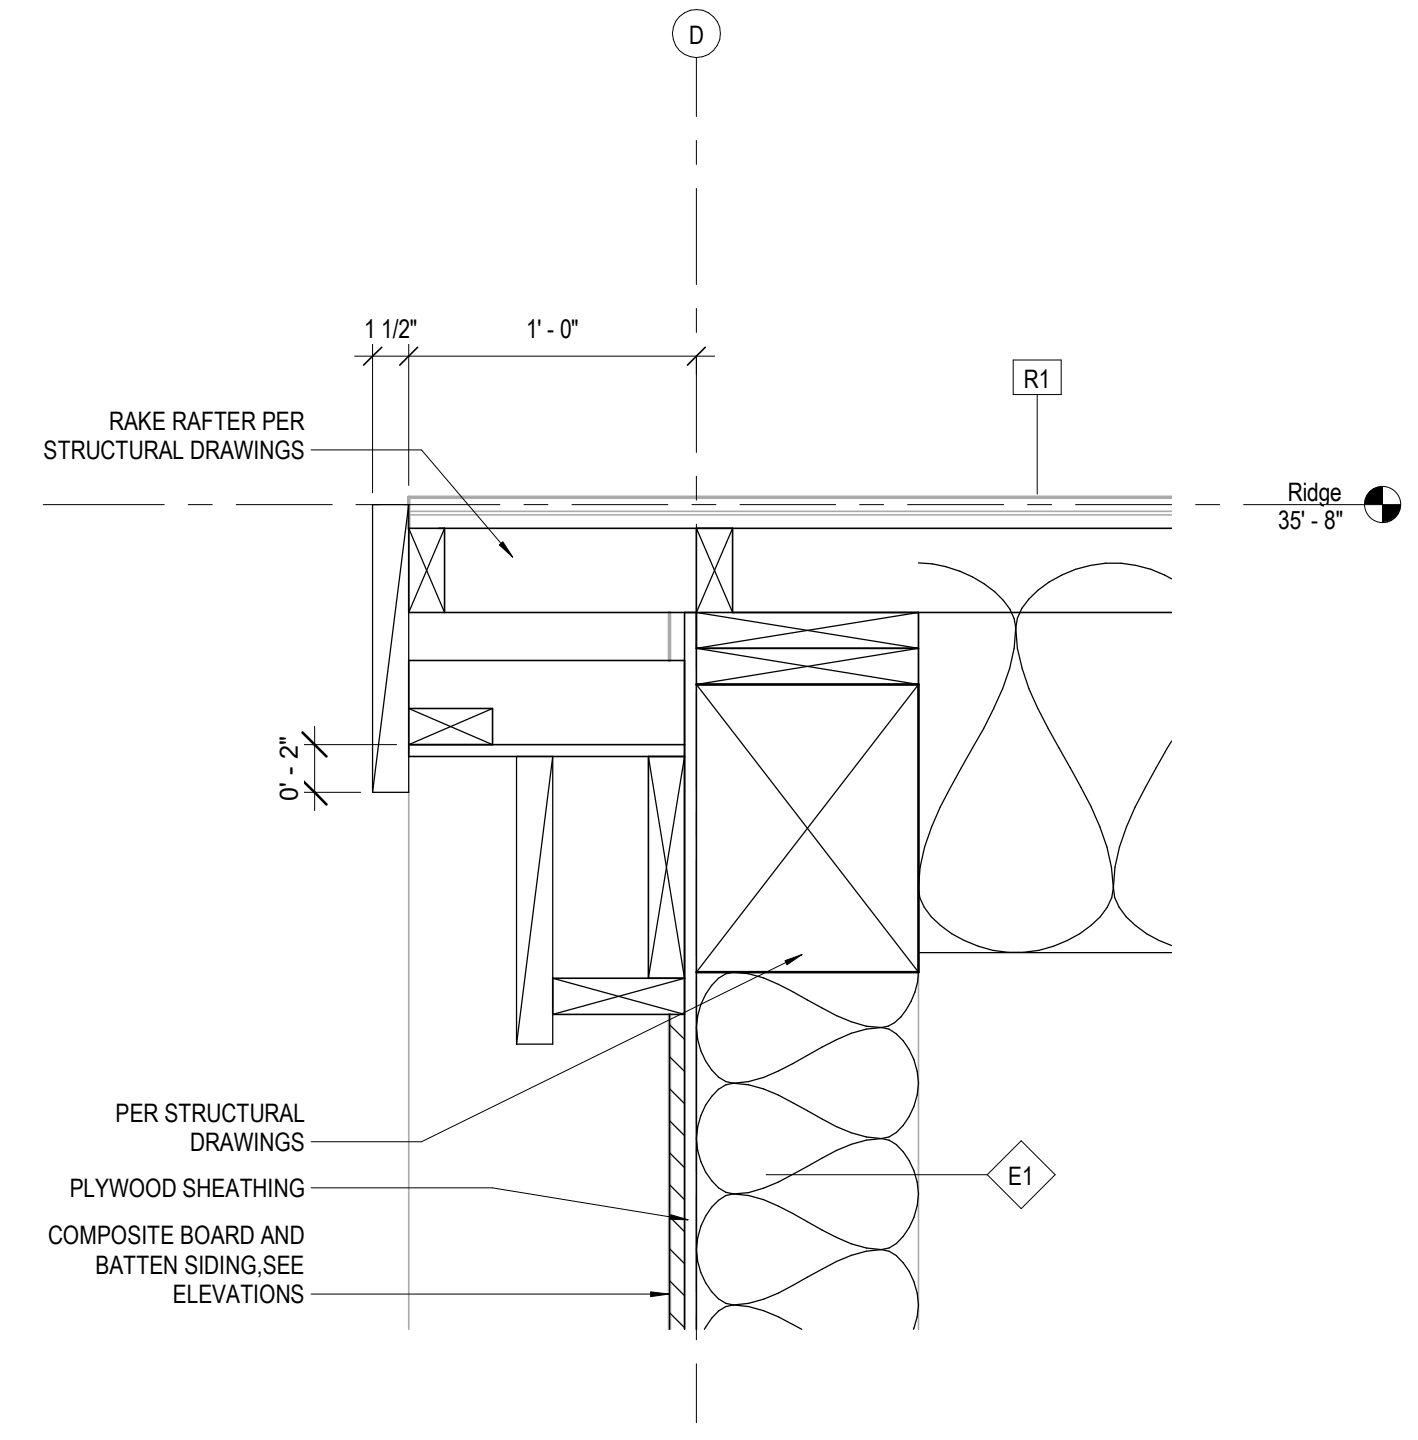


8 Rake Fascia Detail
1 1/2" = 1'-0"

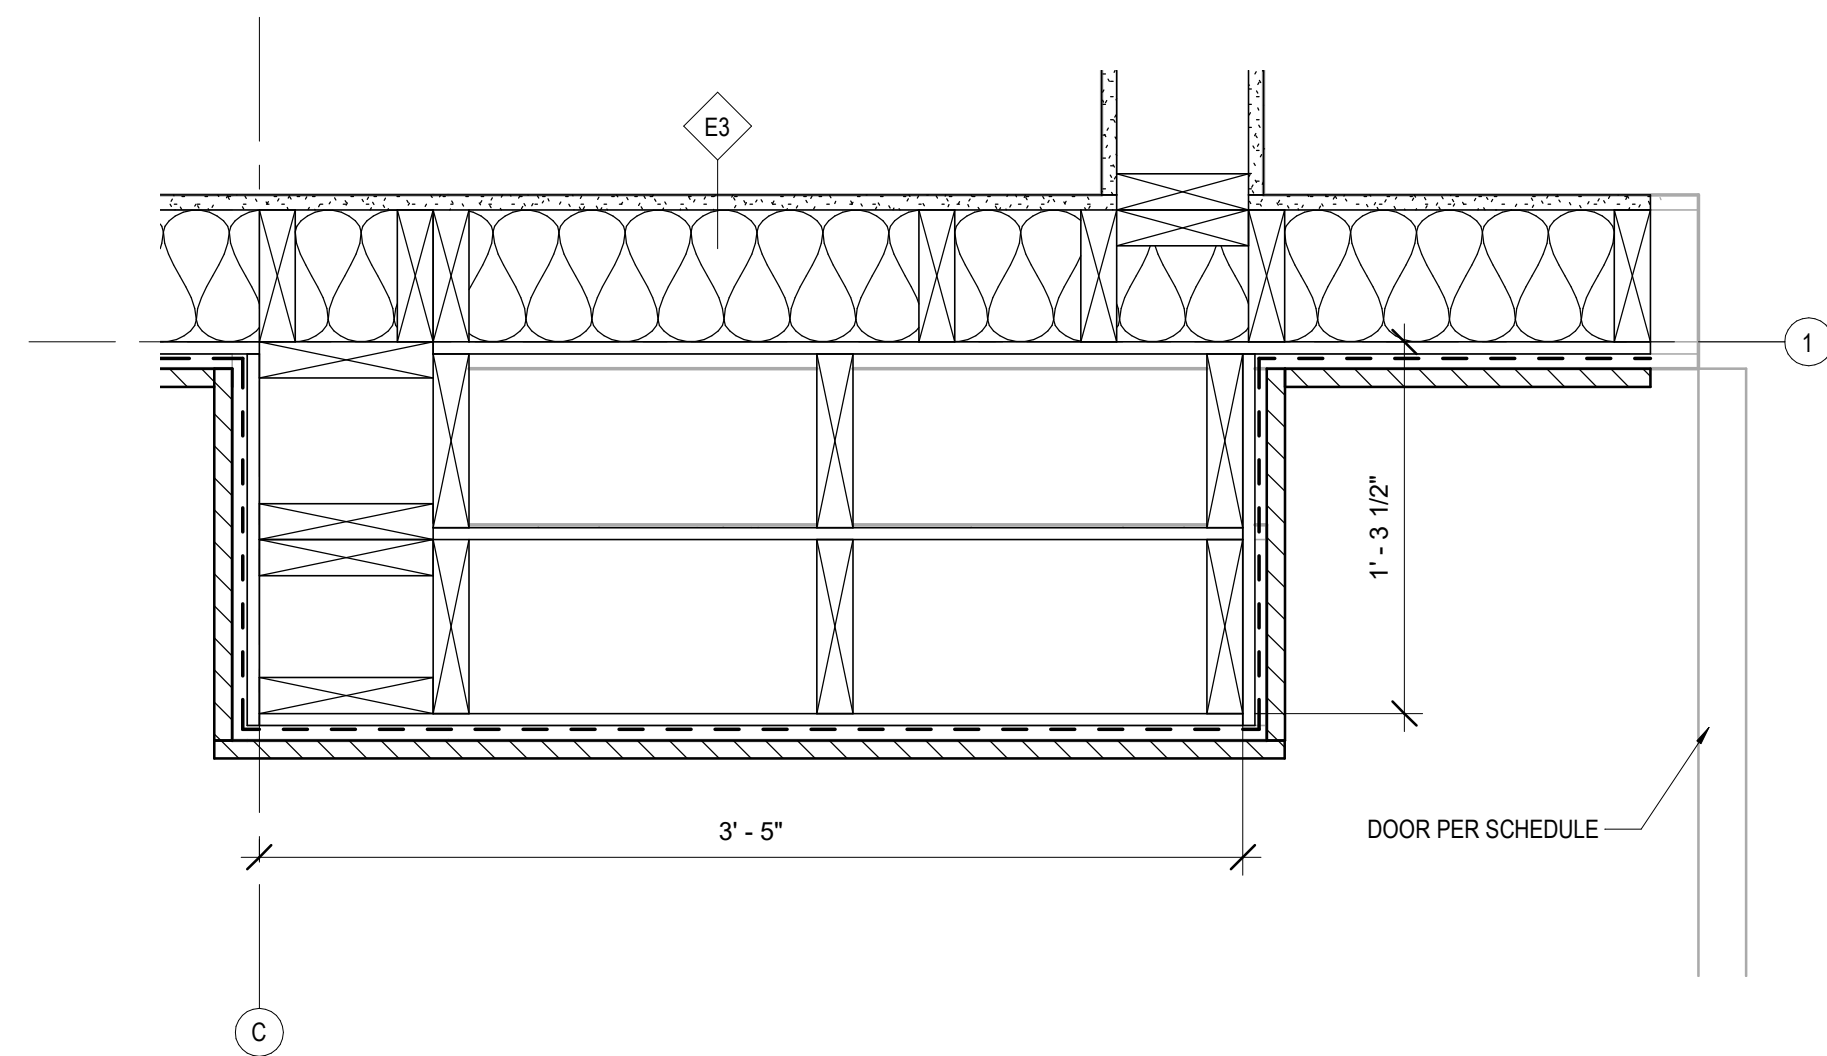


1 Entry Facade Detail - North
1 1/2" = 1'-0"

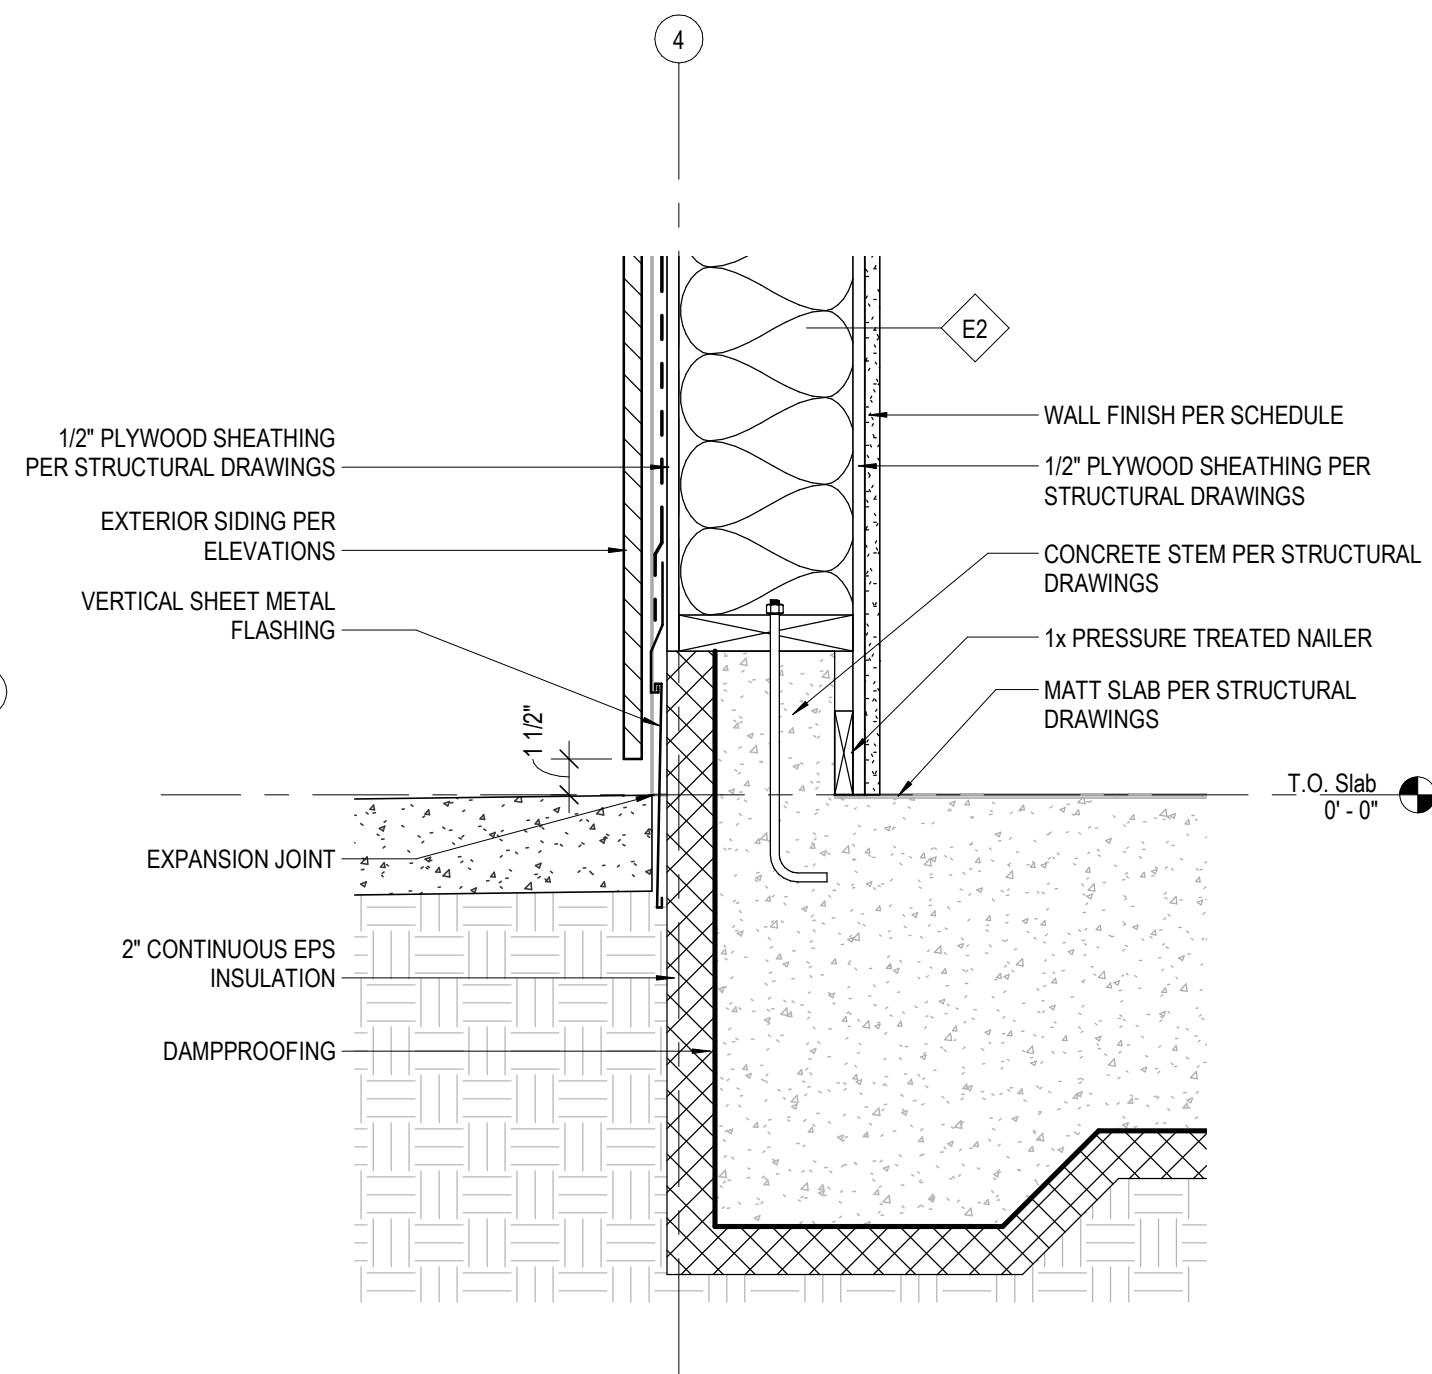


2 Foundation at Gridline 4
1 1/2" = 1'-0"

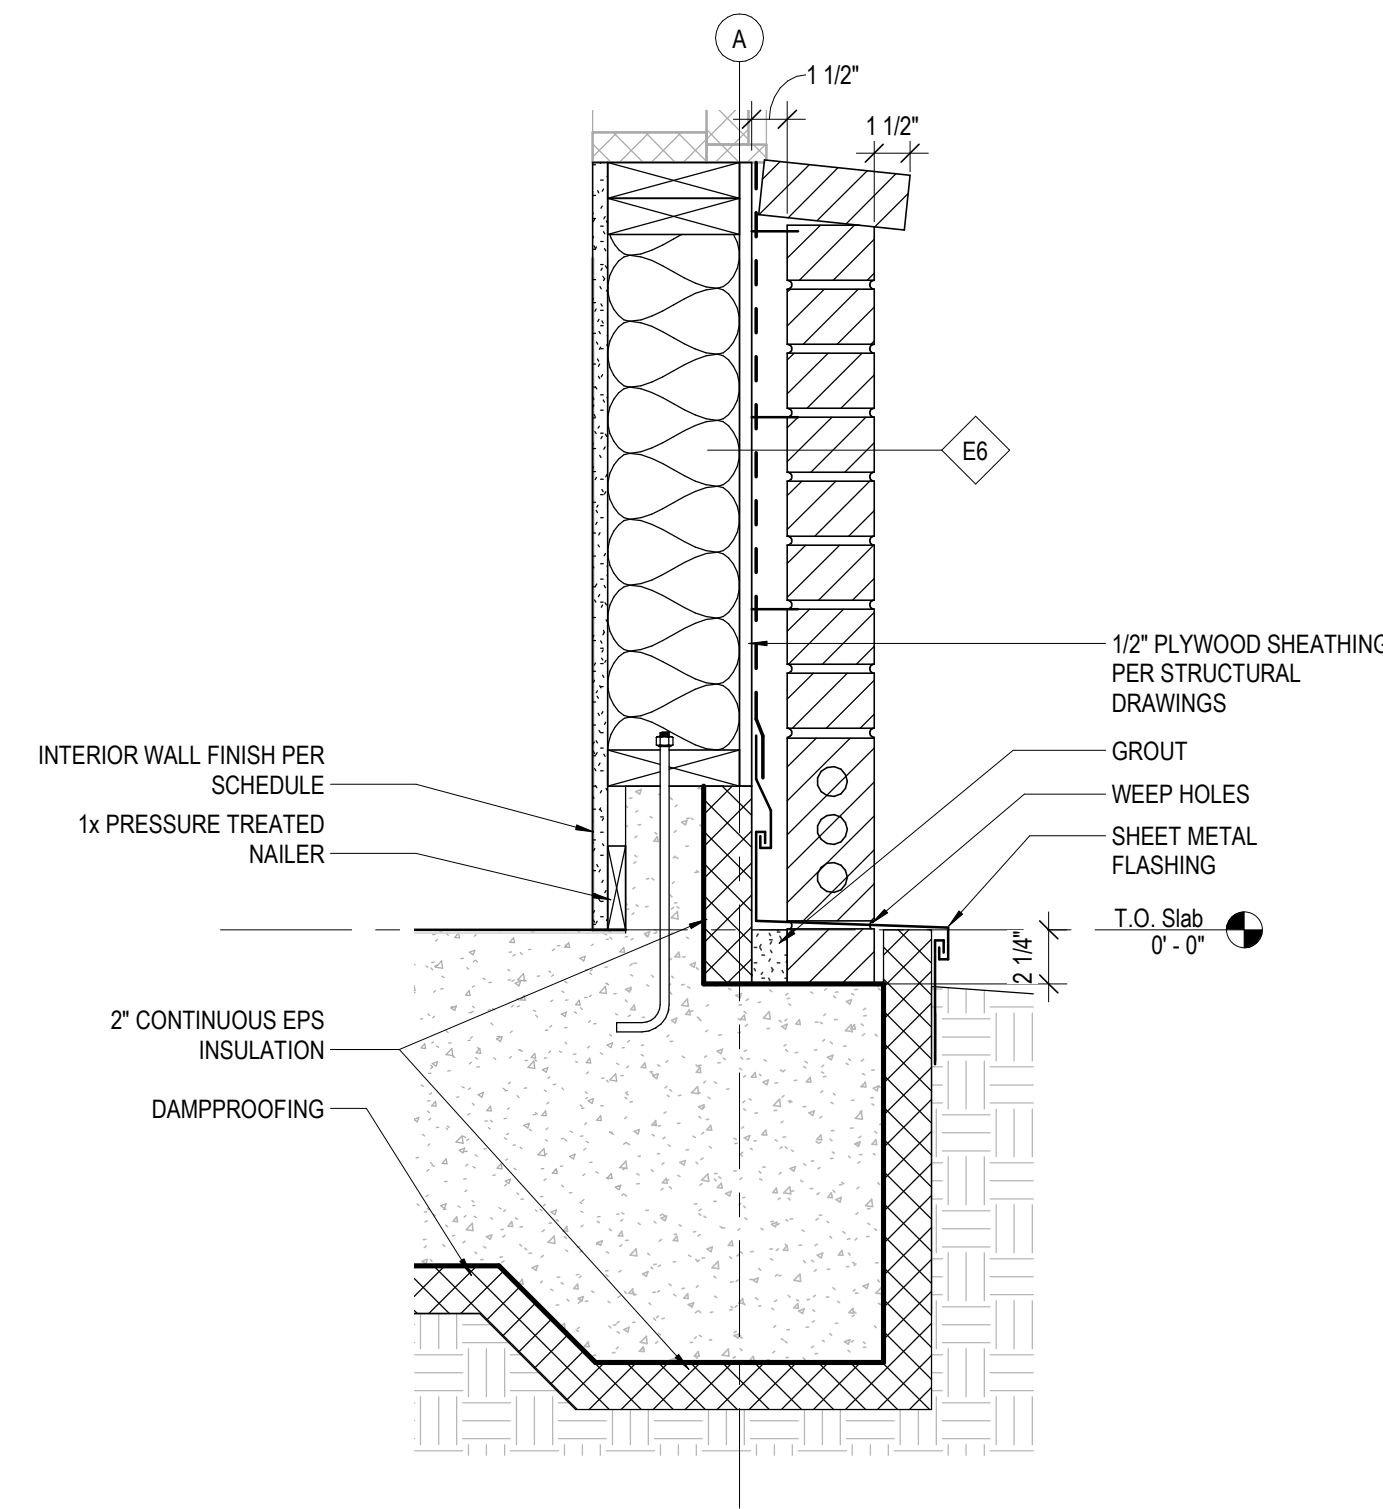


3 Foundation at Brick Veneer
1 1/2" = 1'-0"

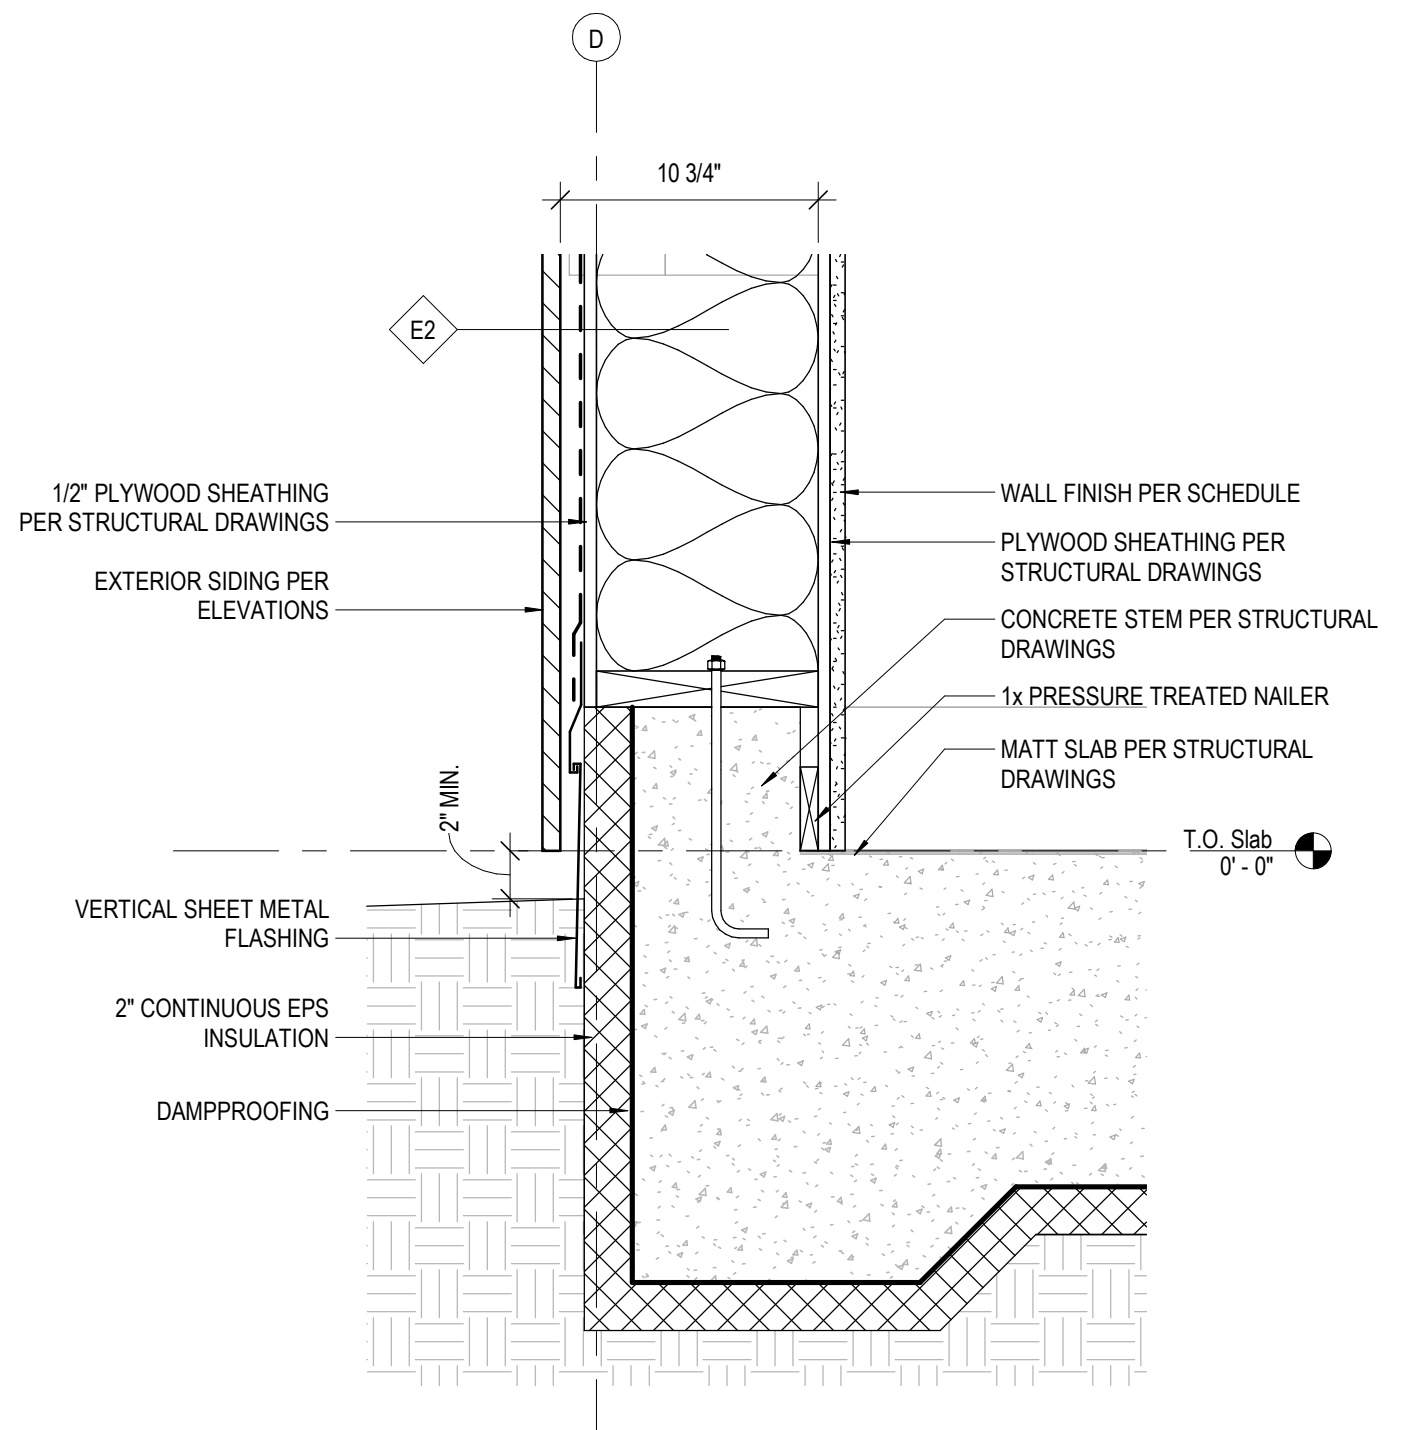


4 Foundation Detail
1 1/2" = 1'-0"

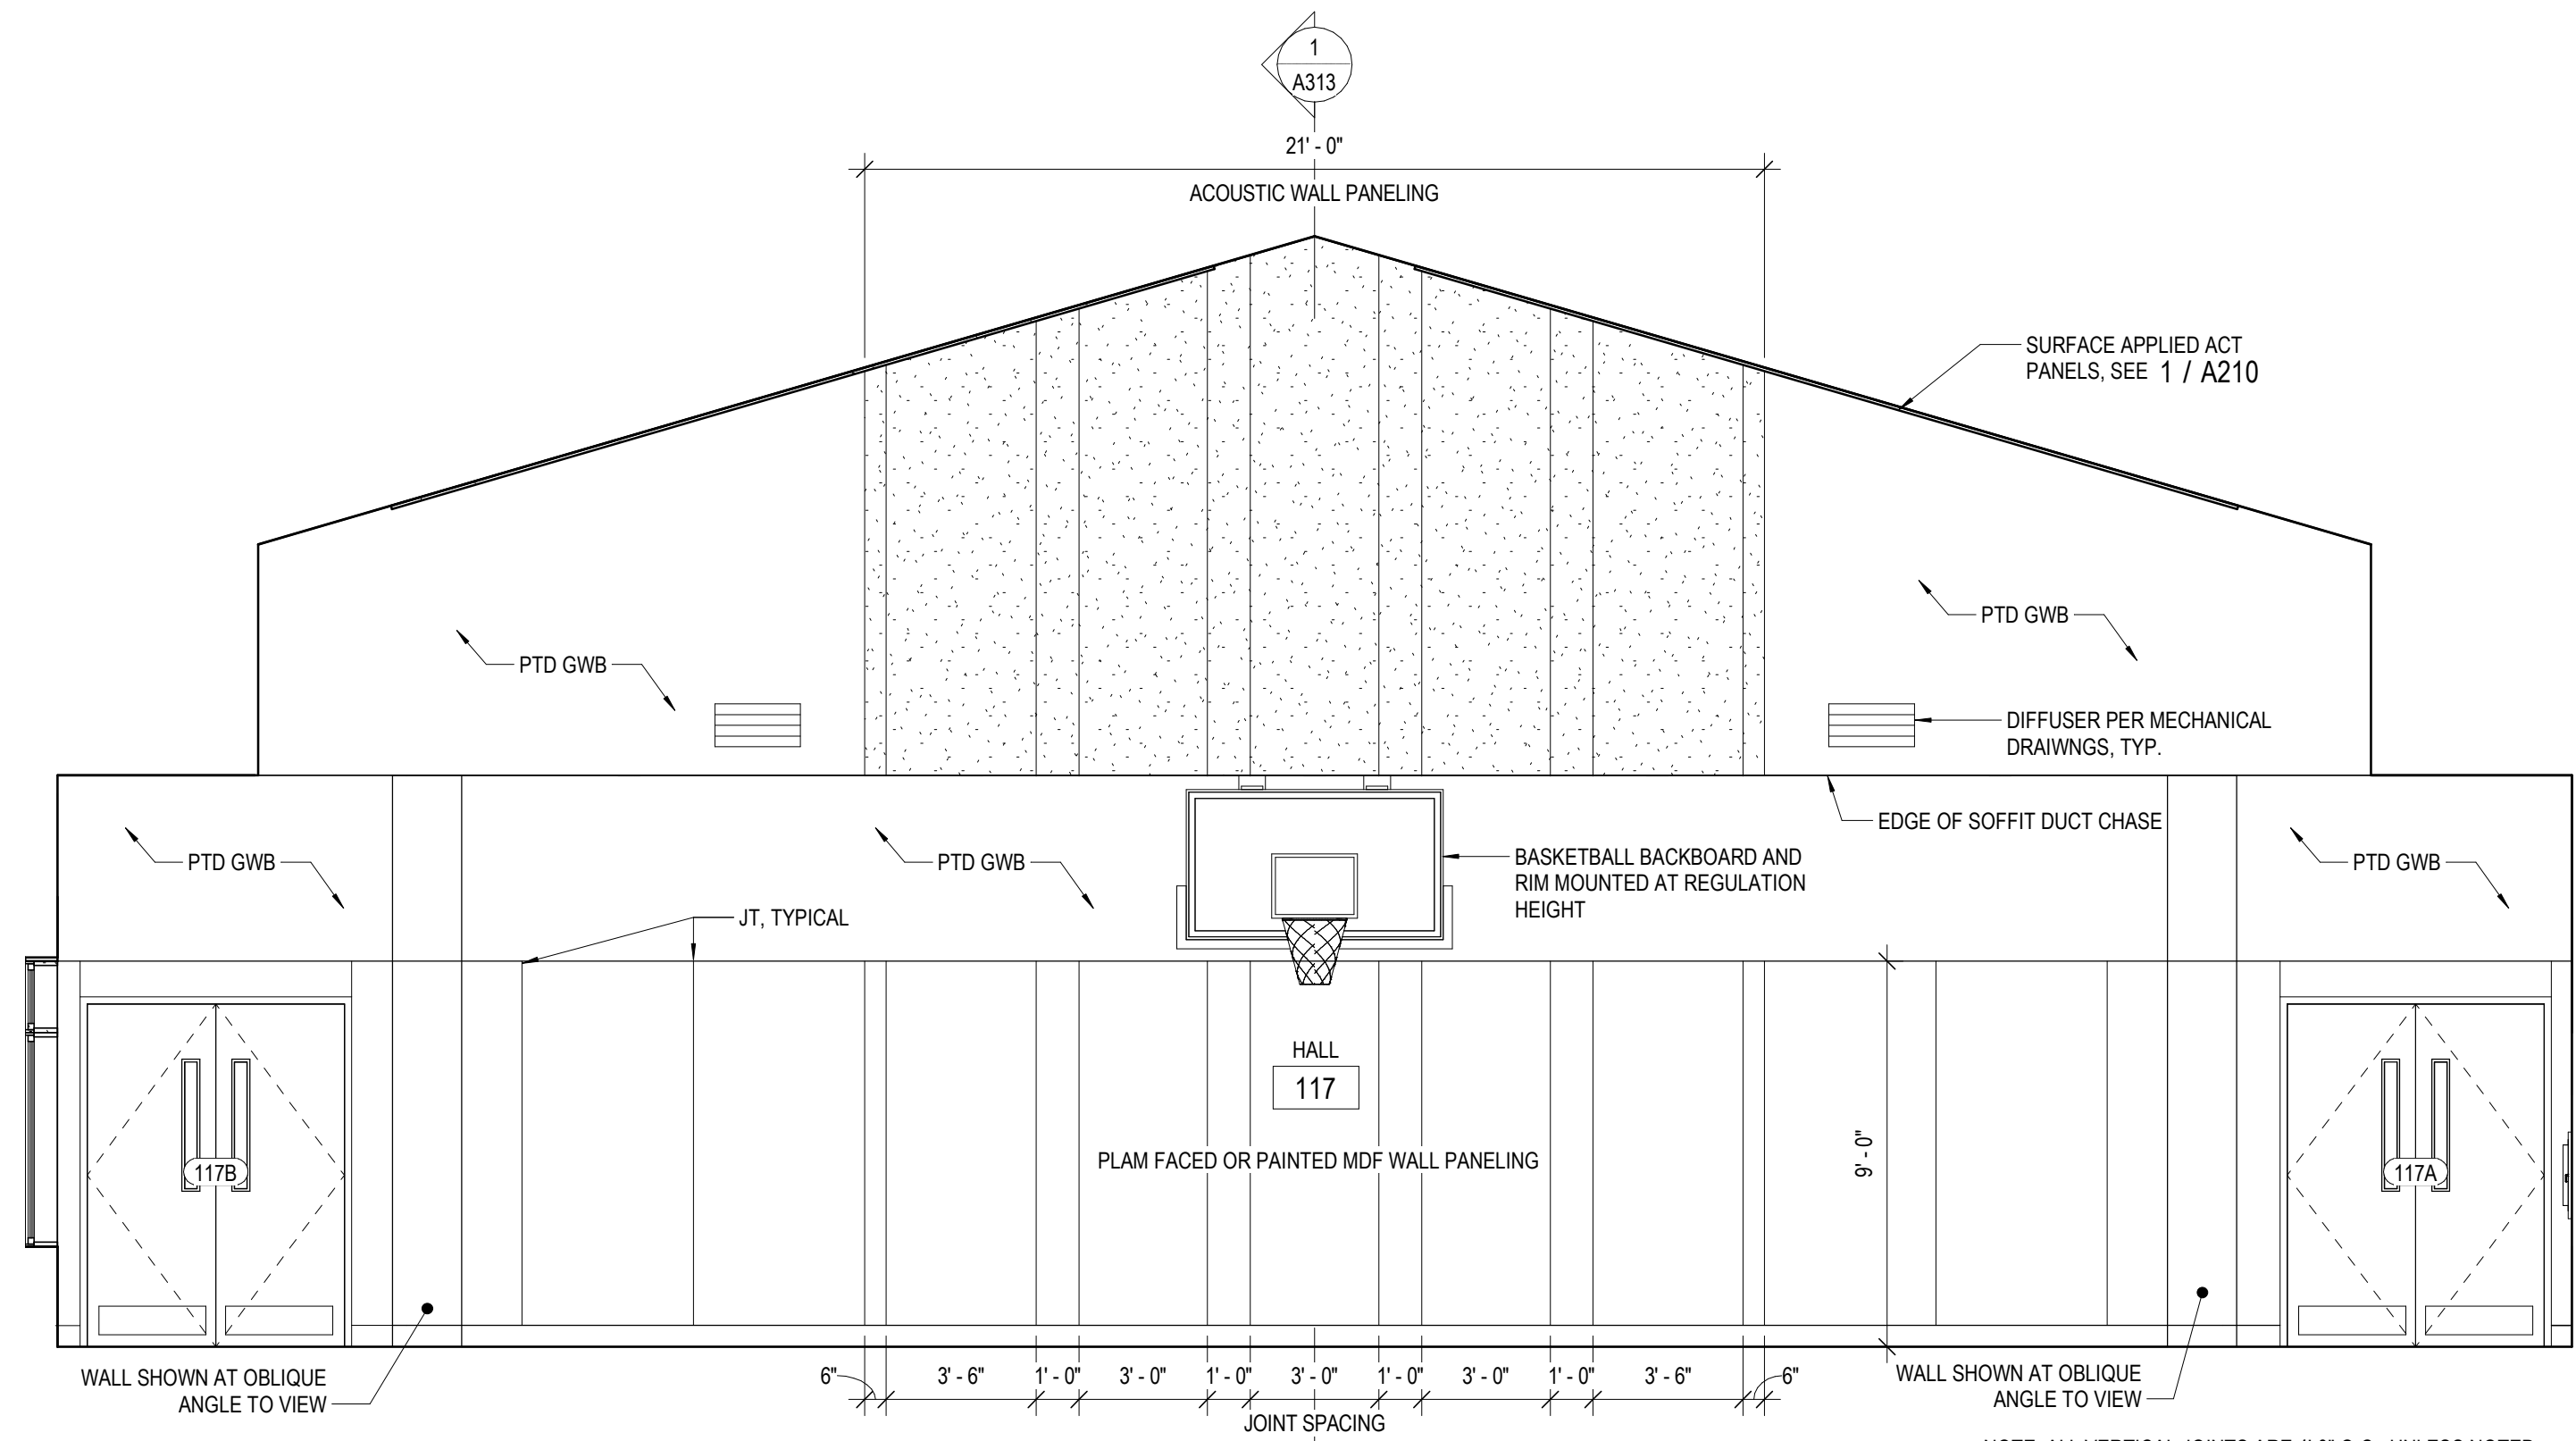


2 Hall West
1/4" = 1'-0"

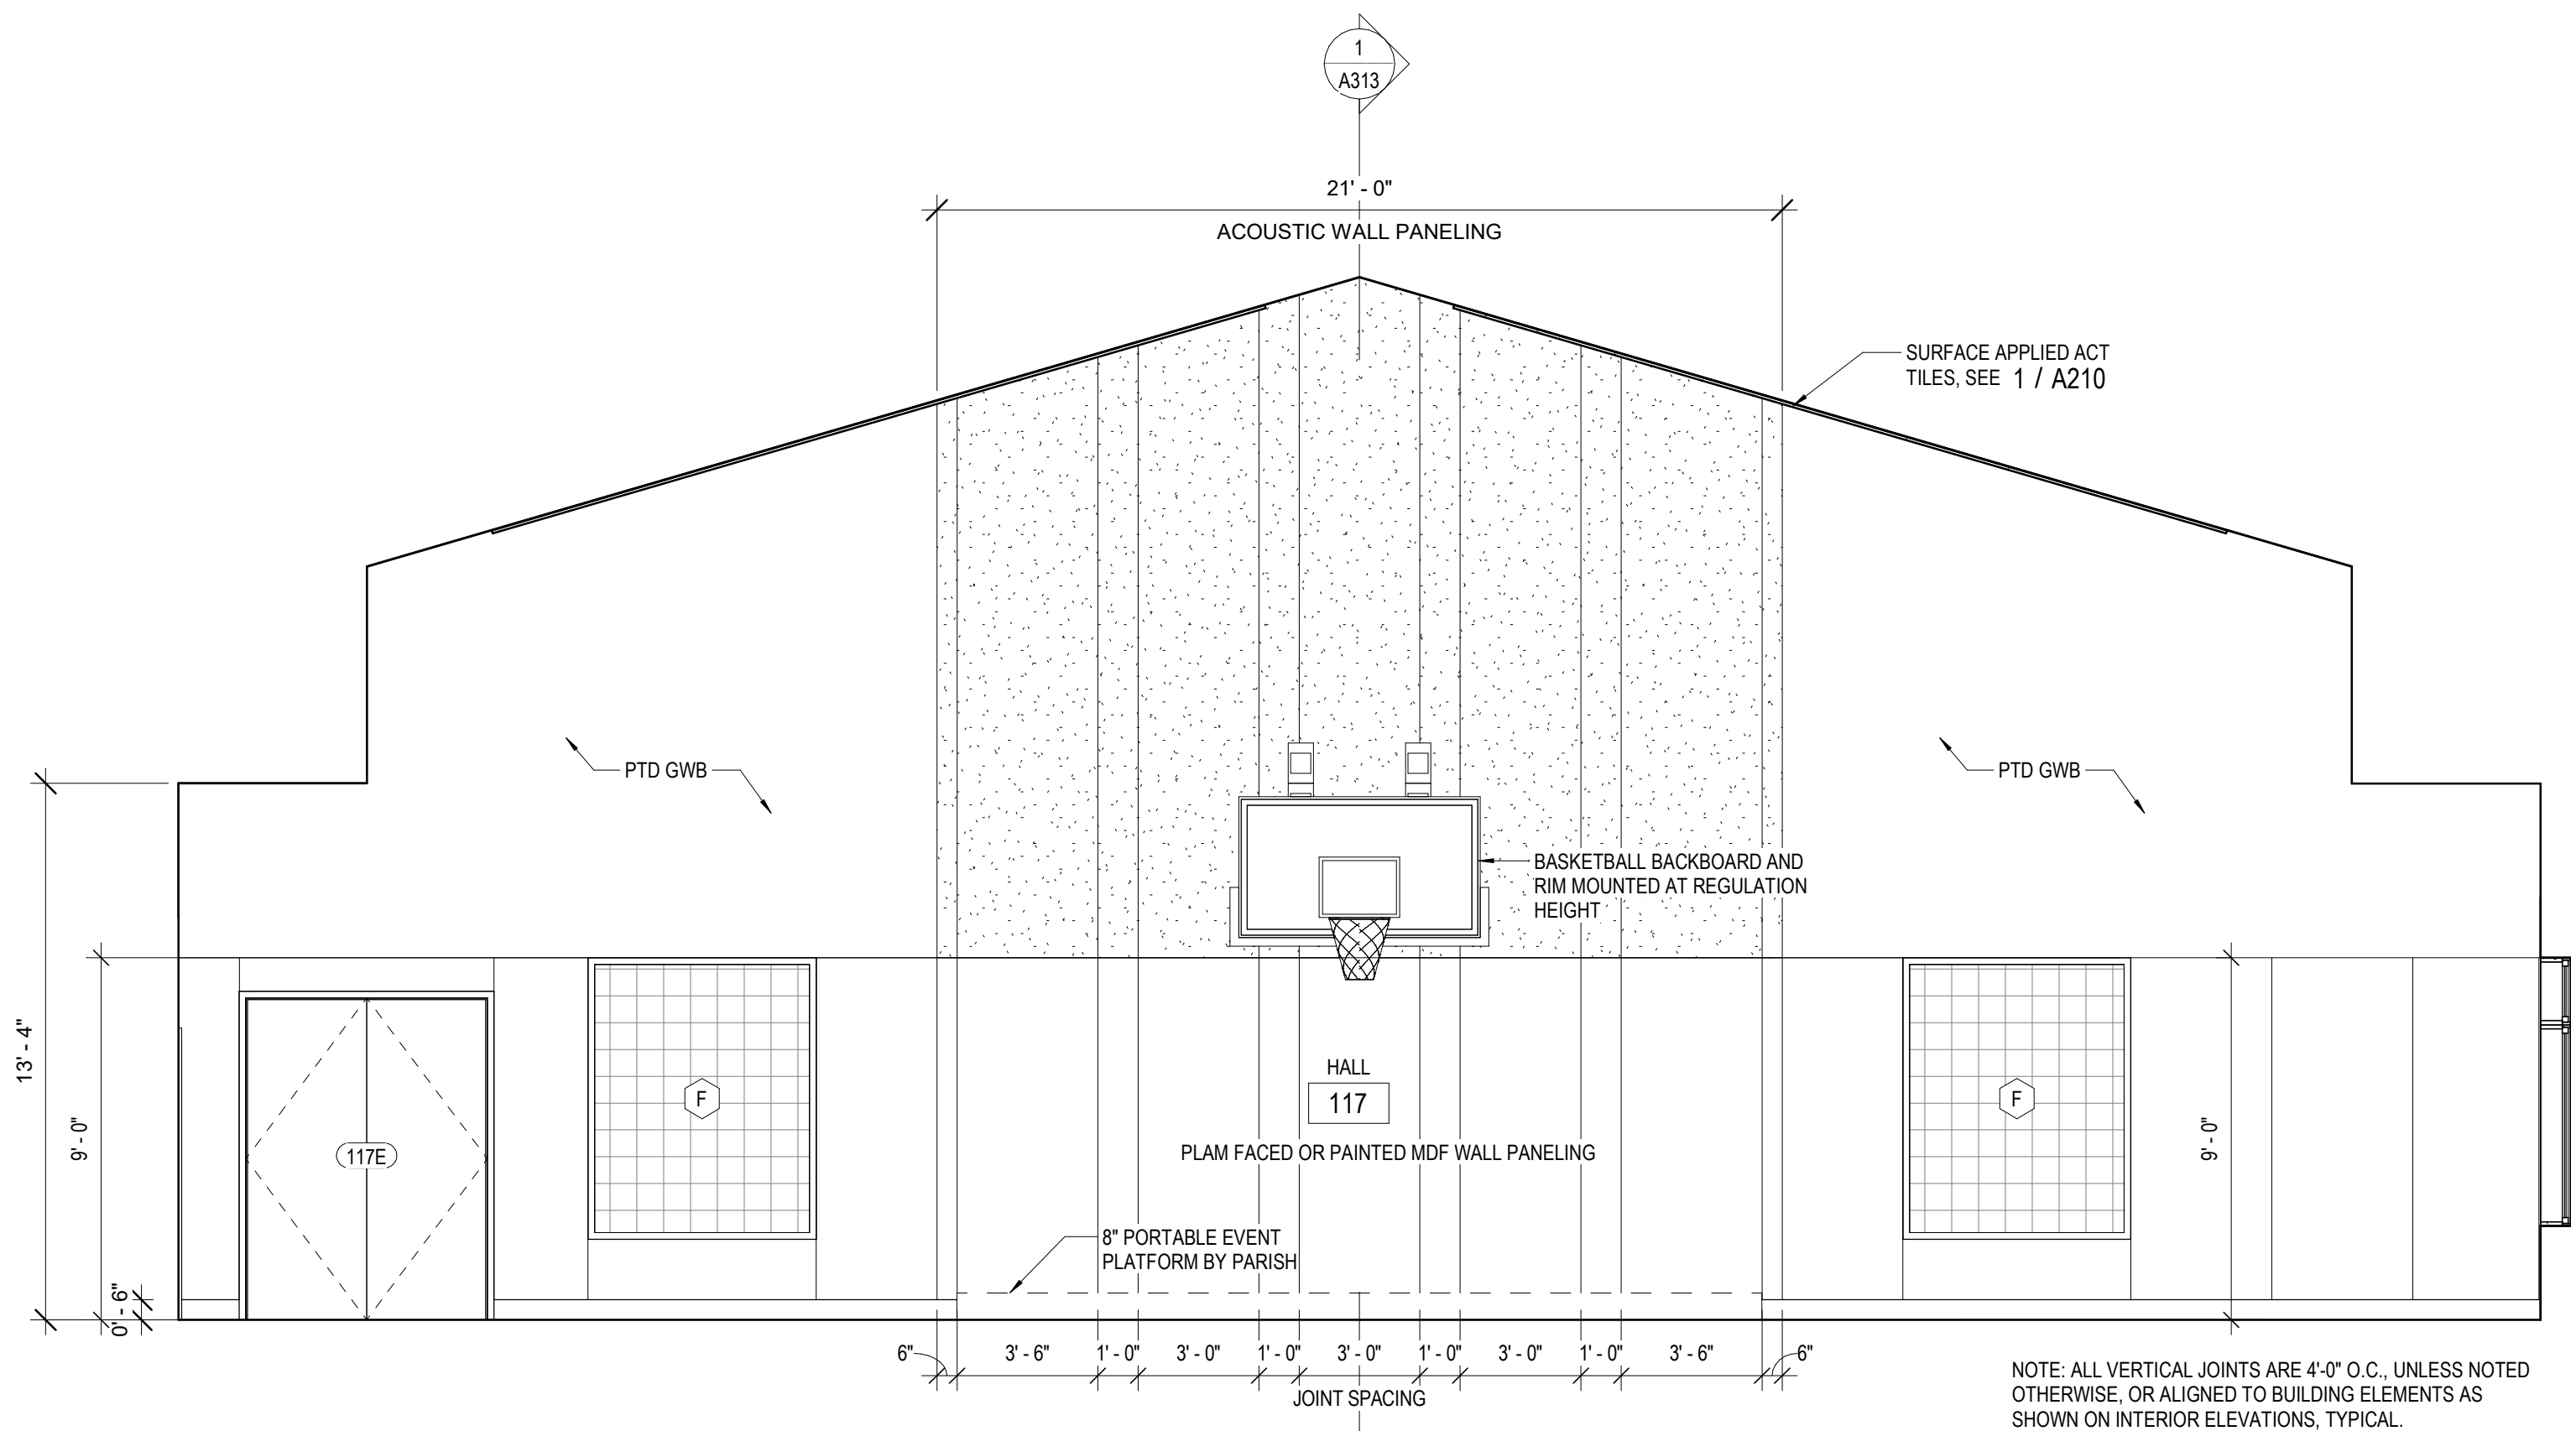


1 Hall East
1/4" = 1'-0"

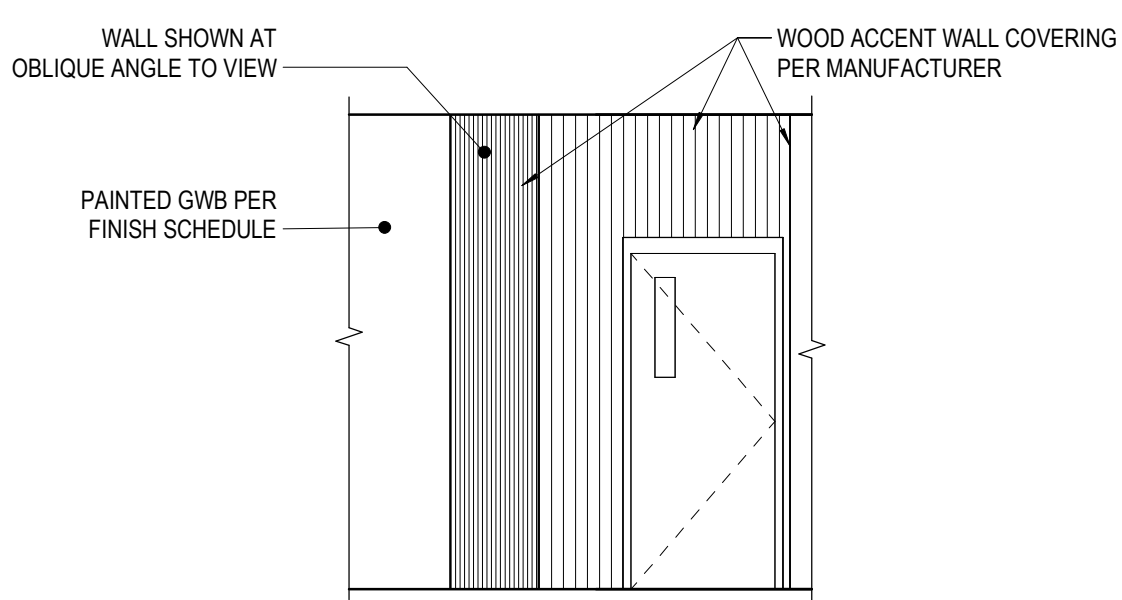


3 Hallway - Typical Door Alcove
1/4" = 1'-0"





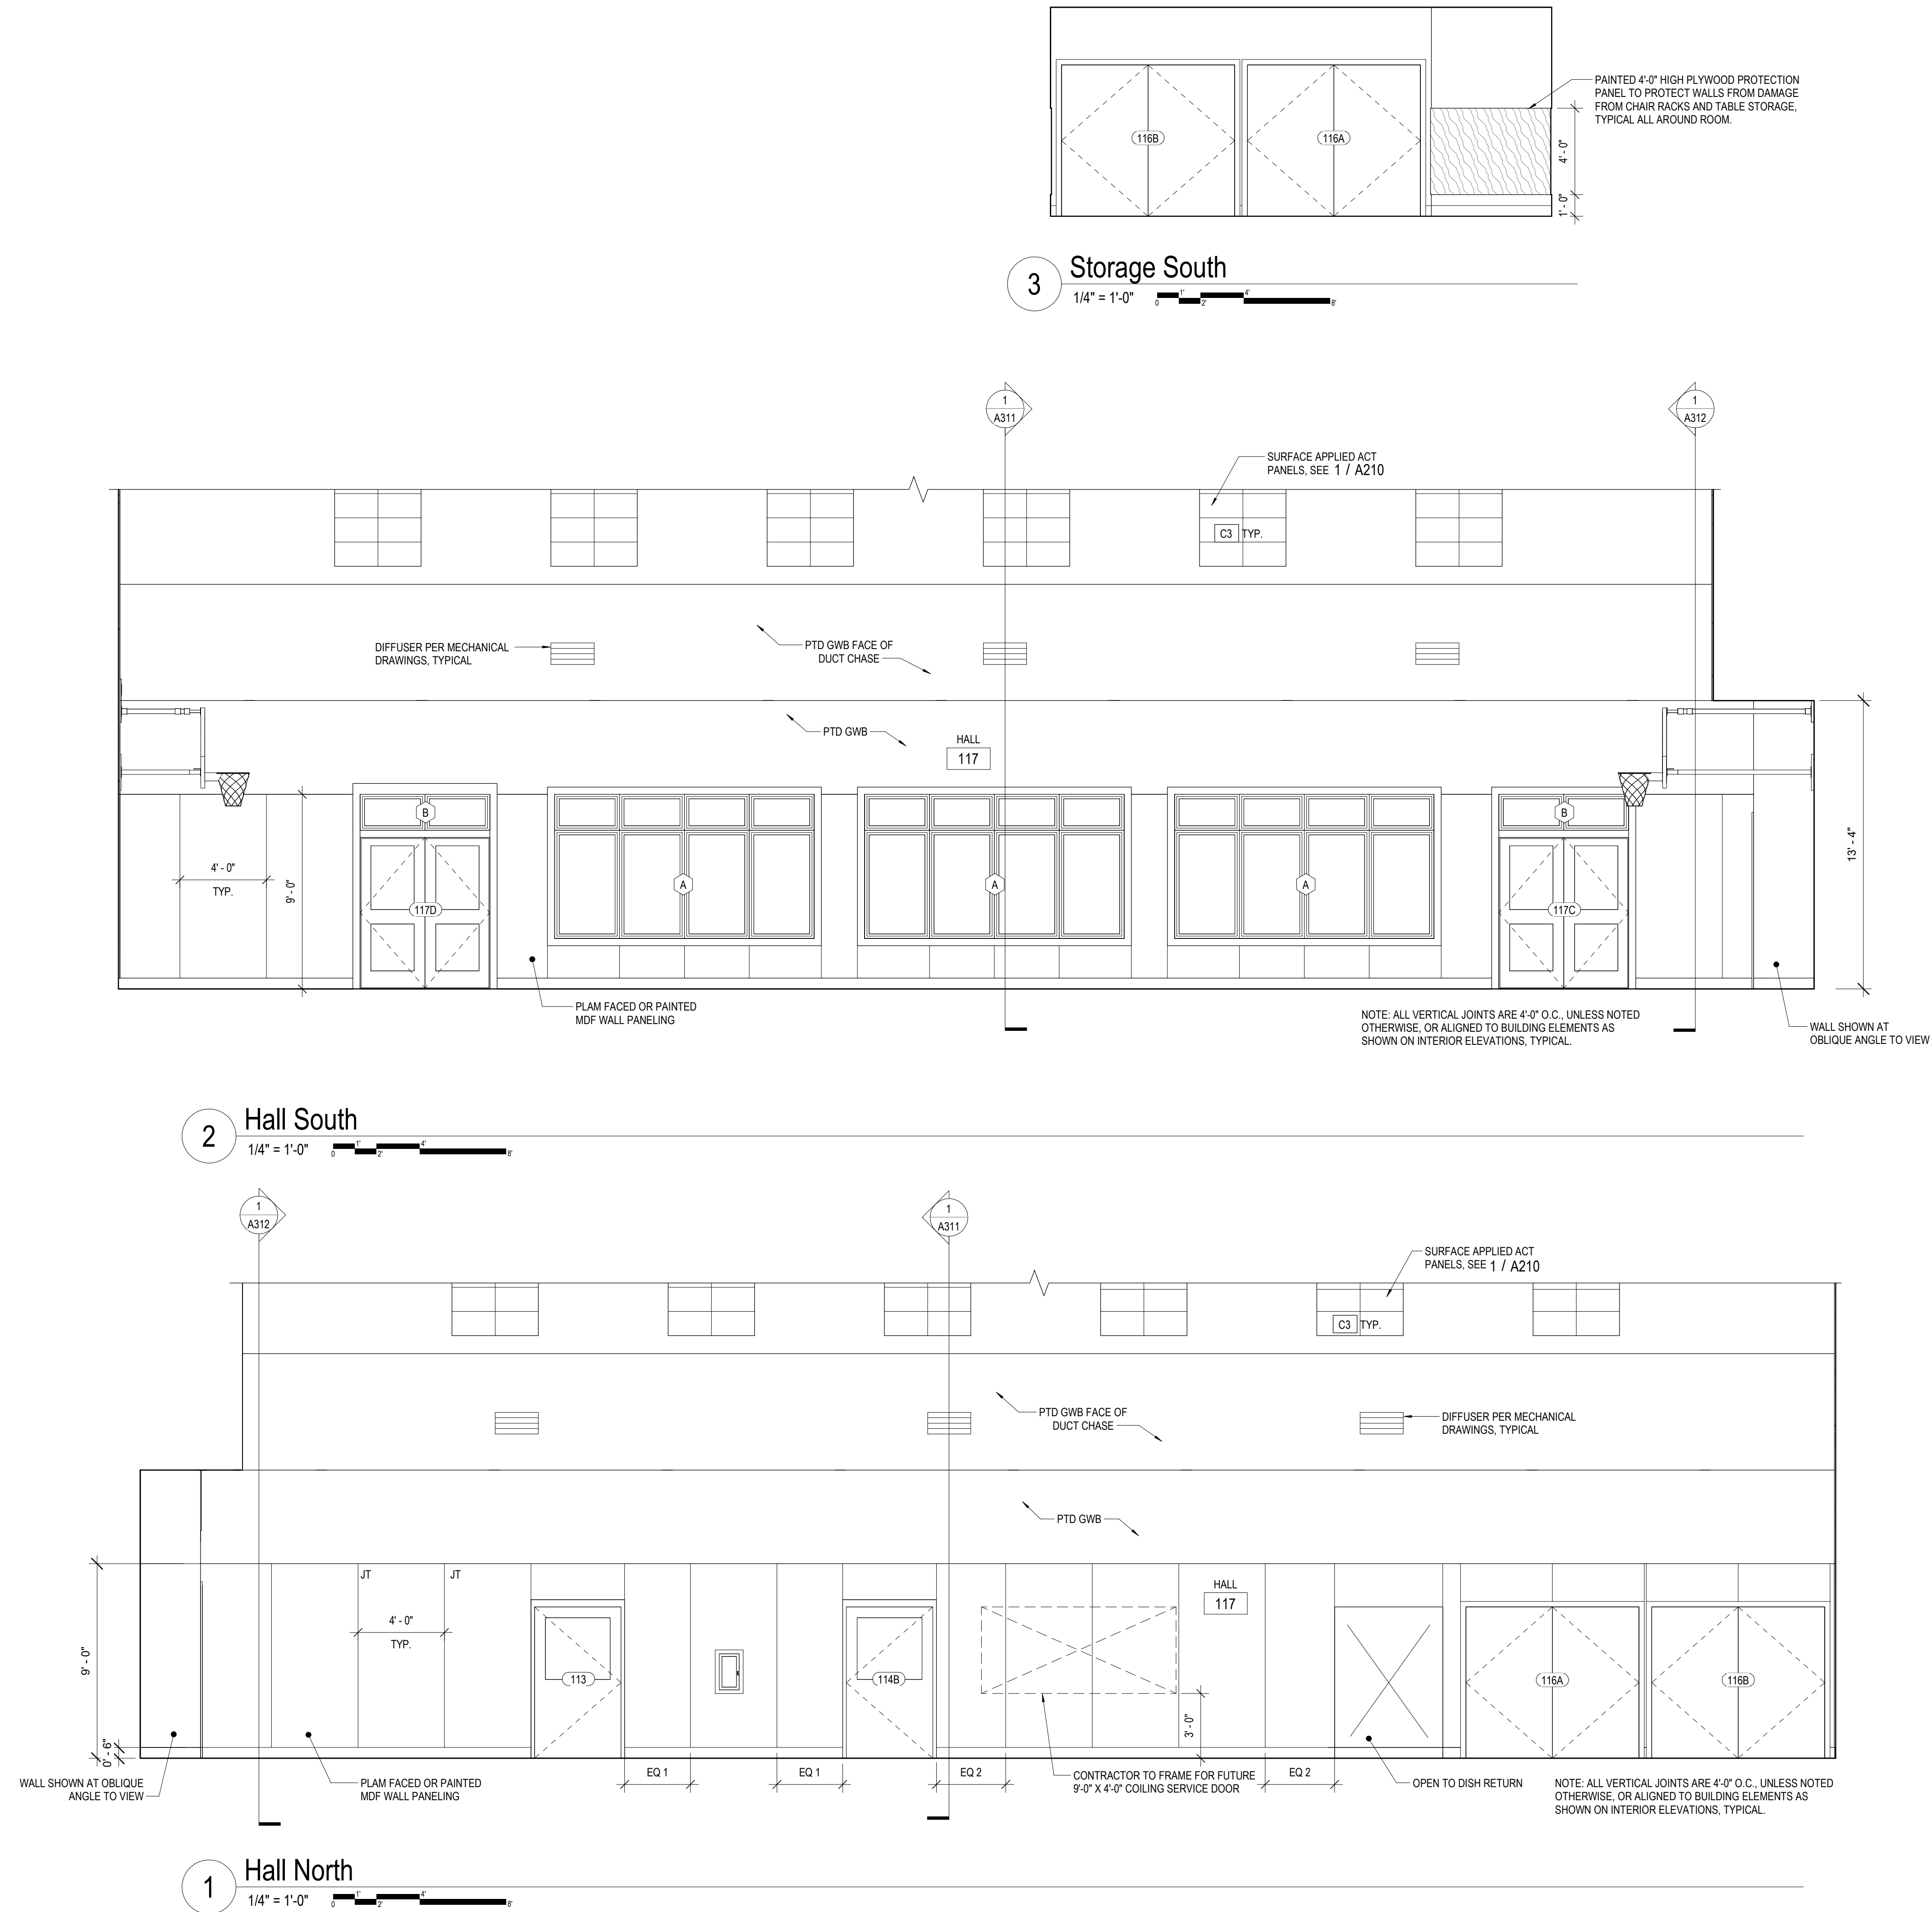


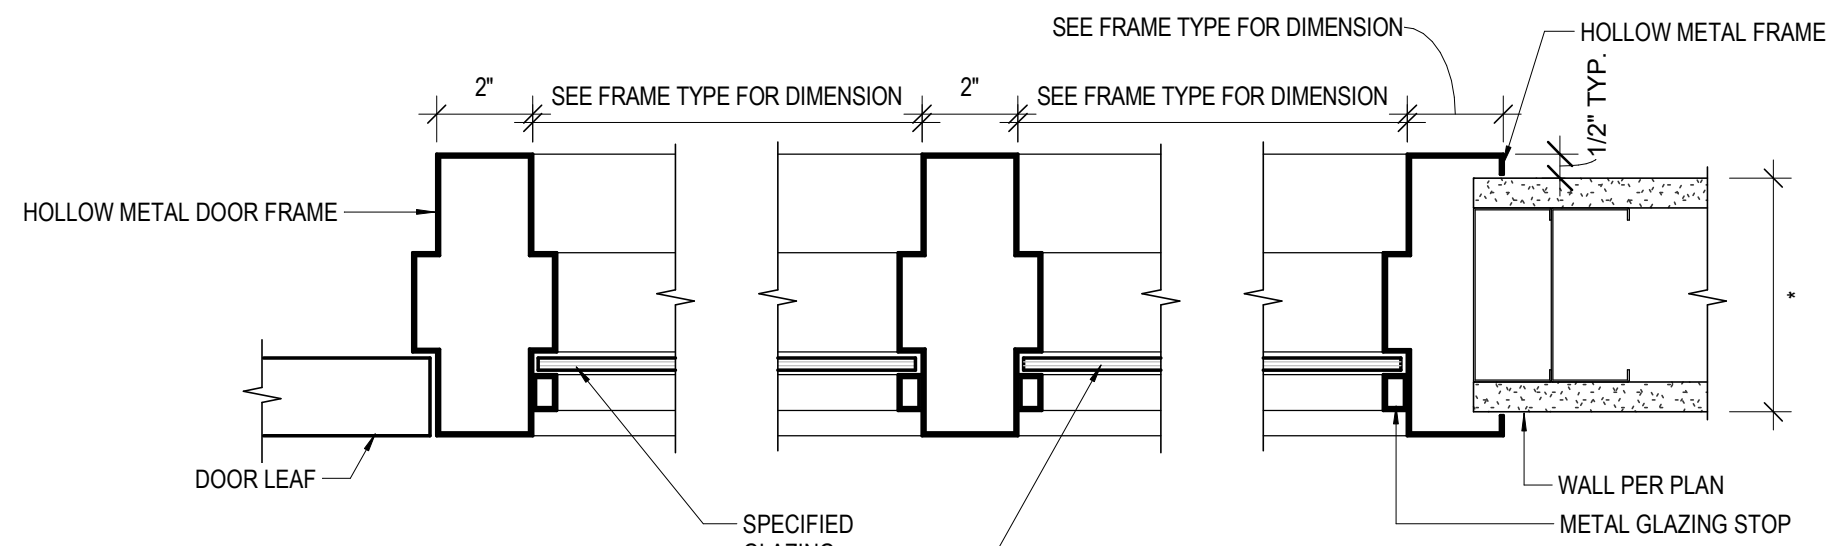

3 Hollow Metal Relight (& Door)
3" = 1'-0"

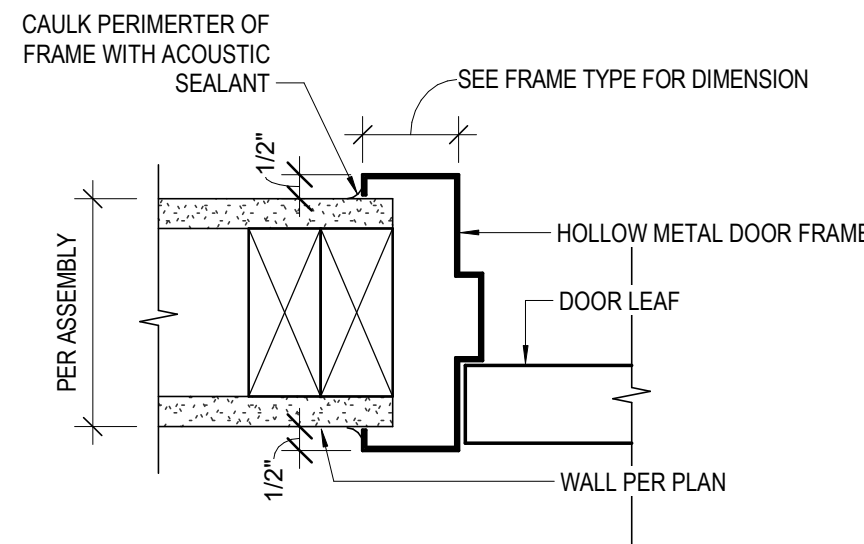


1 Hollow Metal Door Jamb (Head Sim)
3" = 1'-0"

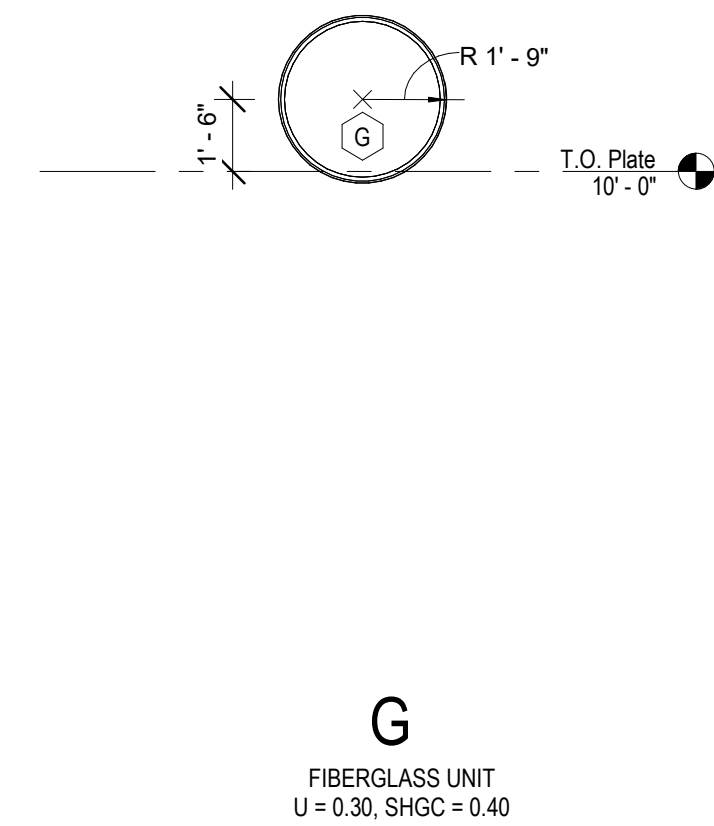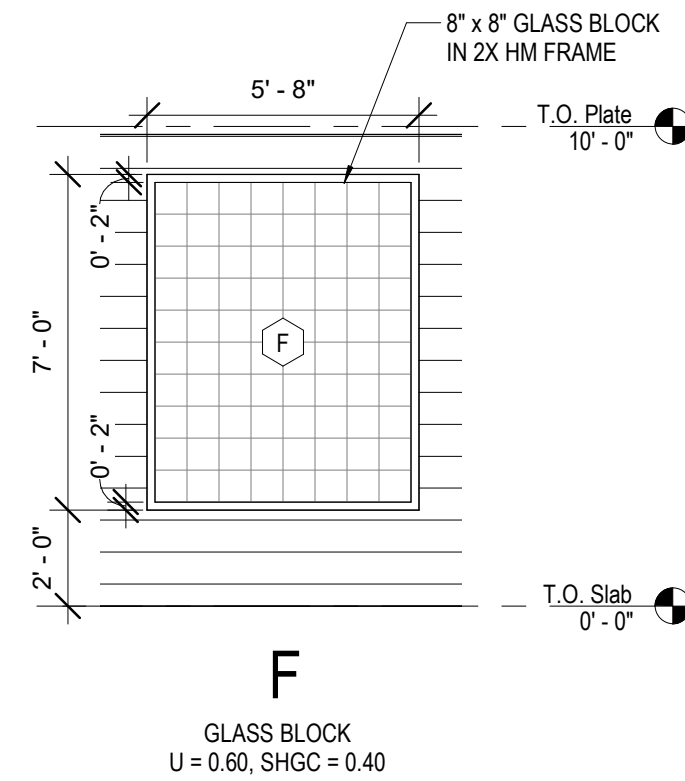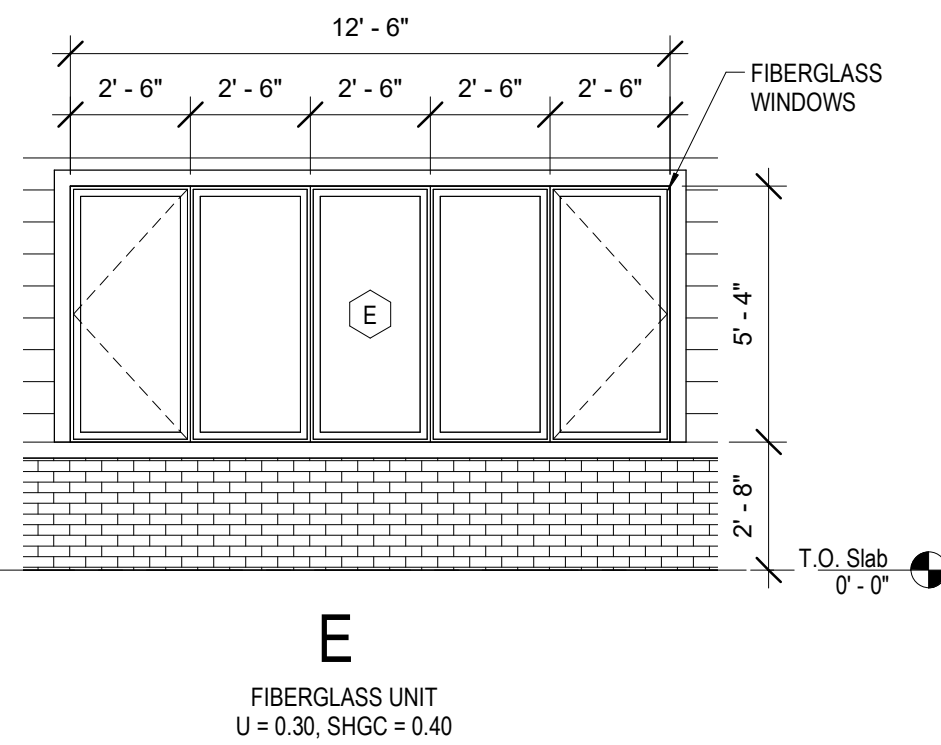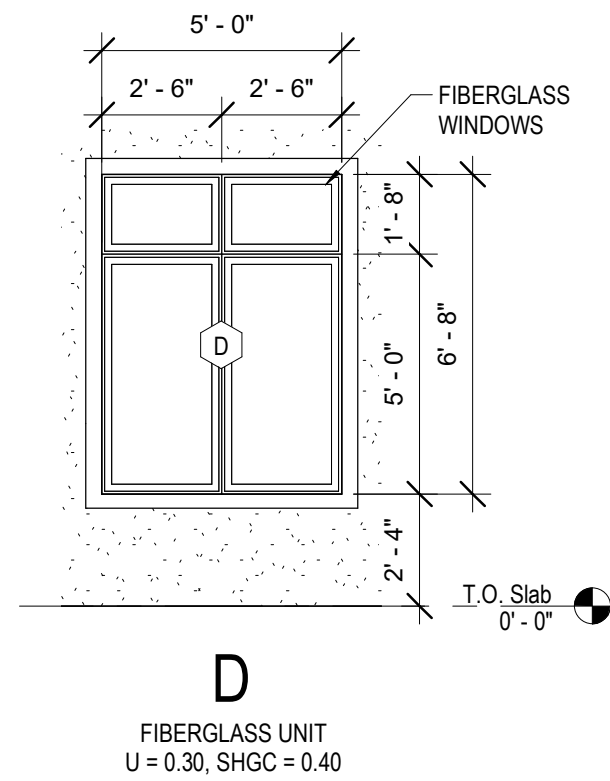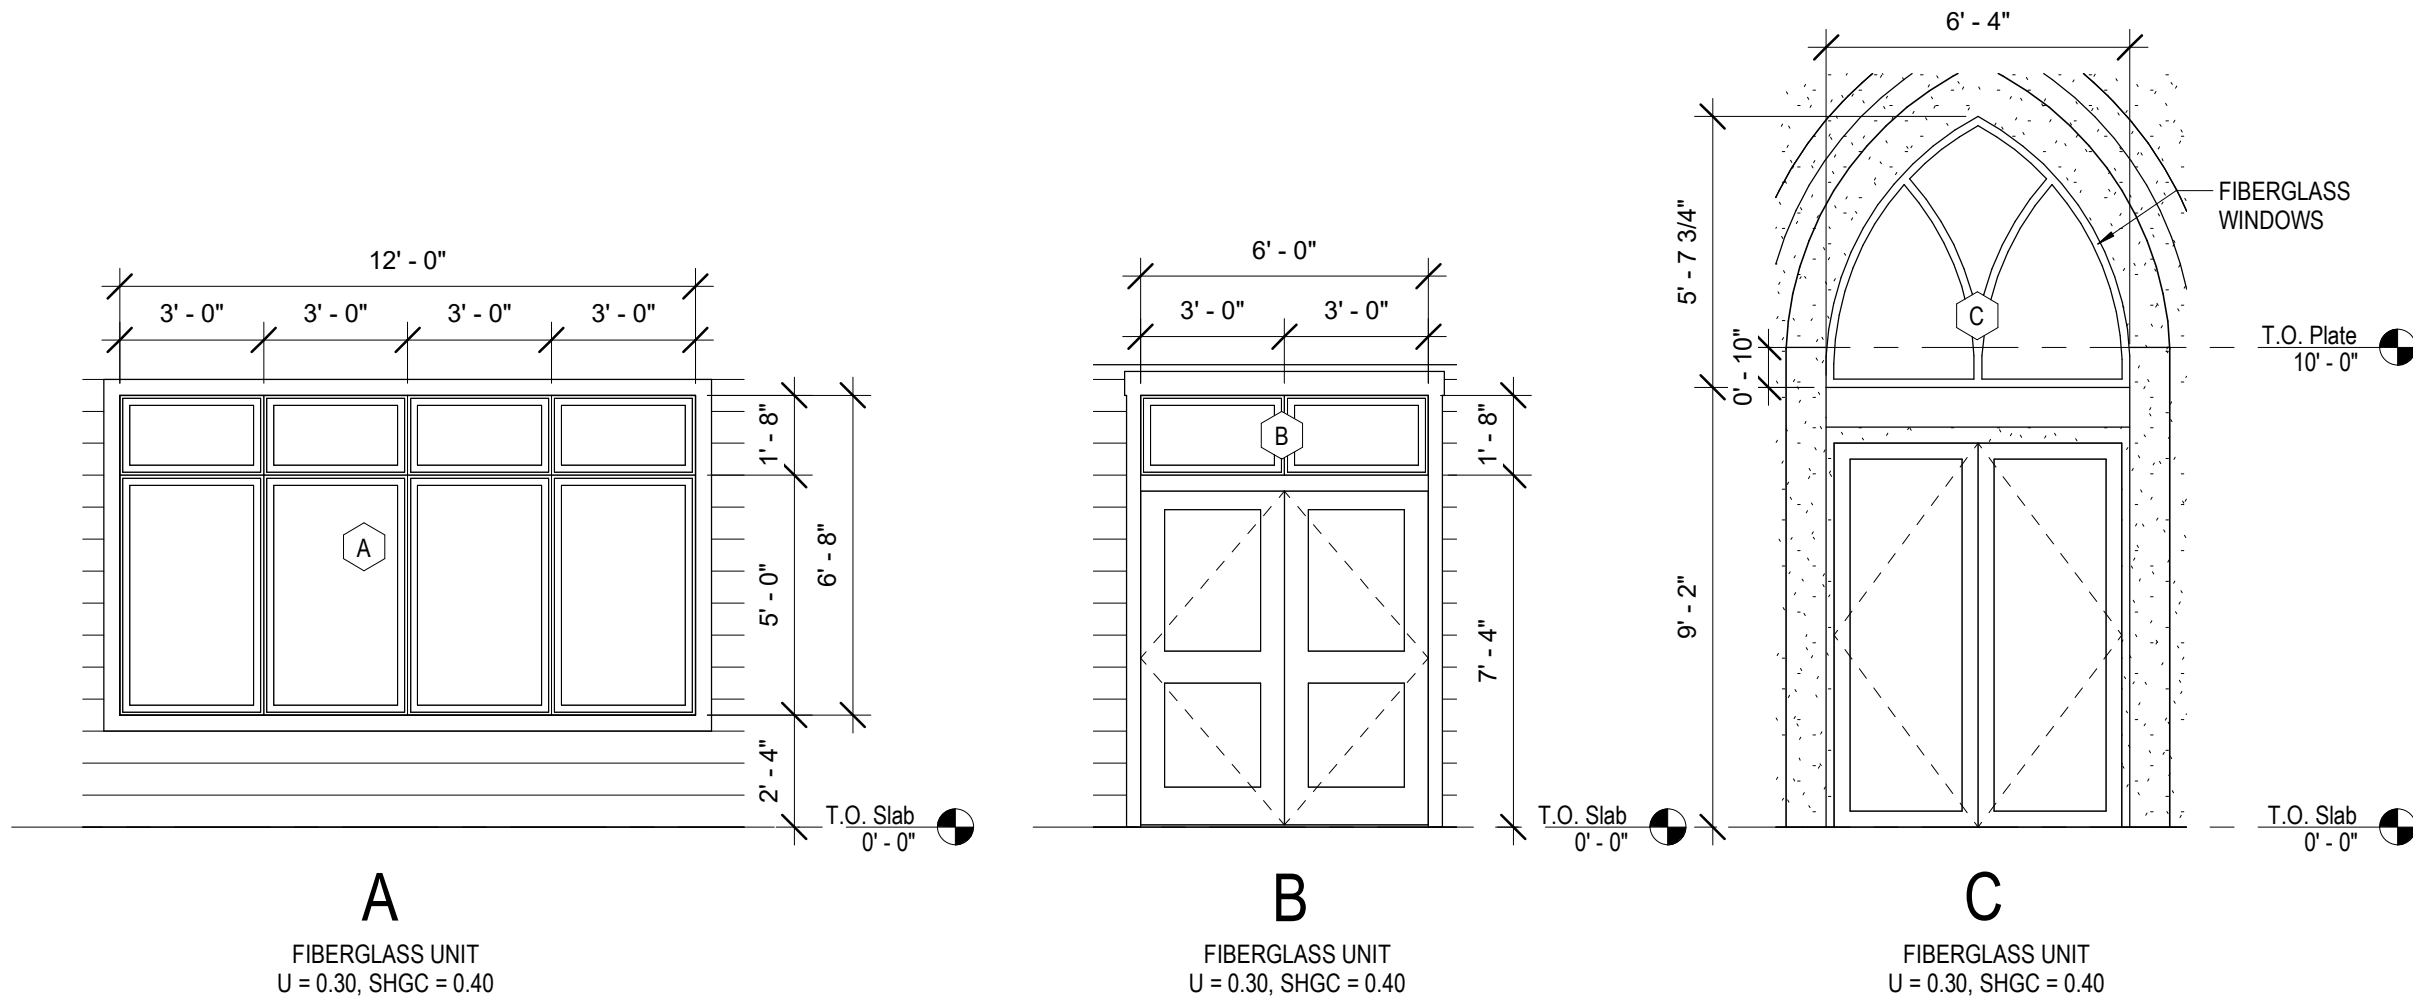

Window Types


WINDOW TYPES GENERAL NOTES

- SOME WINDOWS SHOWN ARE INTENDED FOR DIFFERING WALL ASSEMBLIES, COORDINATE INSTALLATION WITH ASSEMBLIES AND DETAILS.
- SEE INTERIOR FINISH PLANS AND FINISH SCHEDULE FOR LOCATIONS OF INTERIOR WINDOW SHADES.

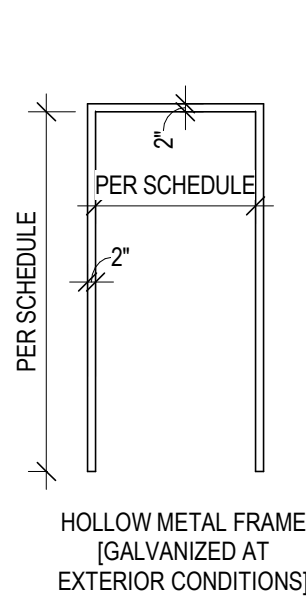


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Door Frame Types

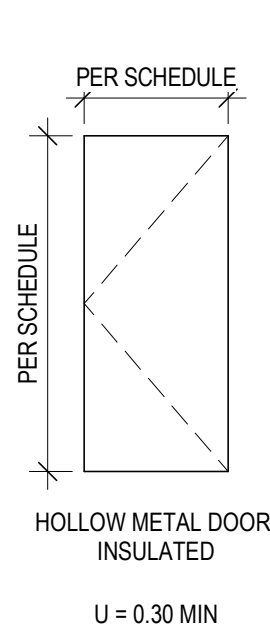


A


Door Types

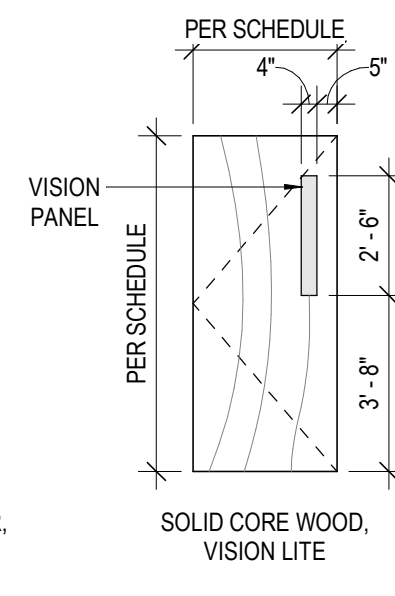


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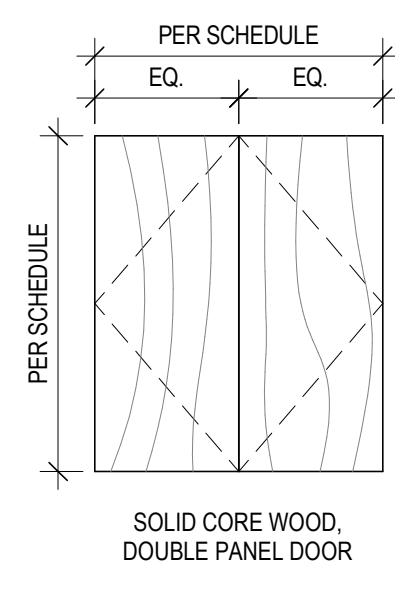
C

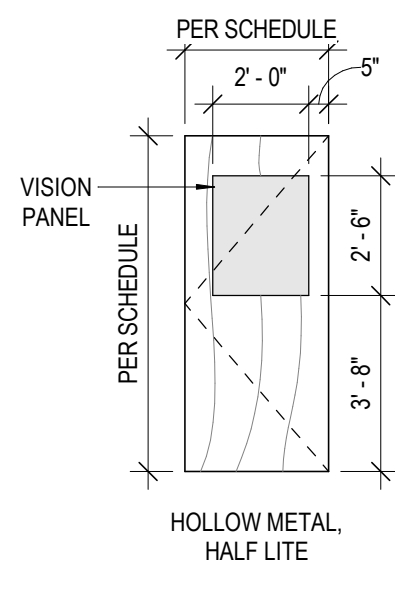

D

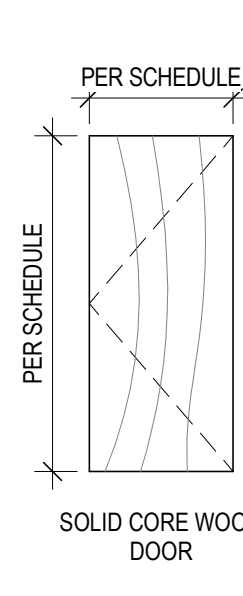


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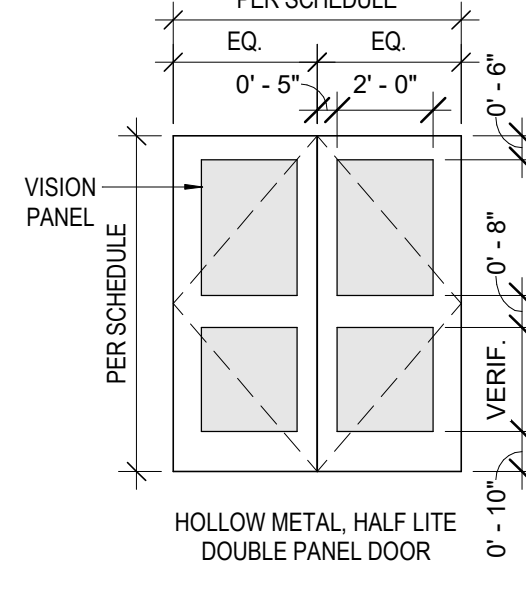
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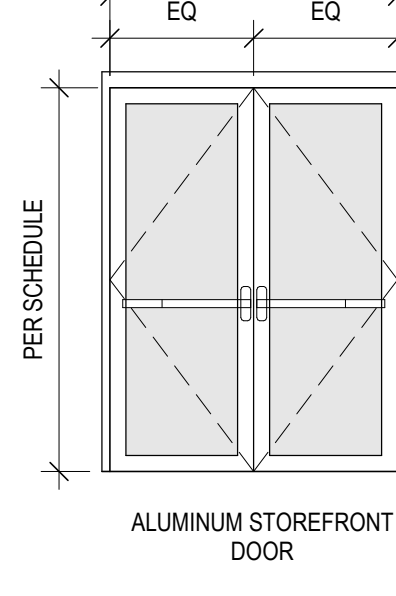
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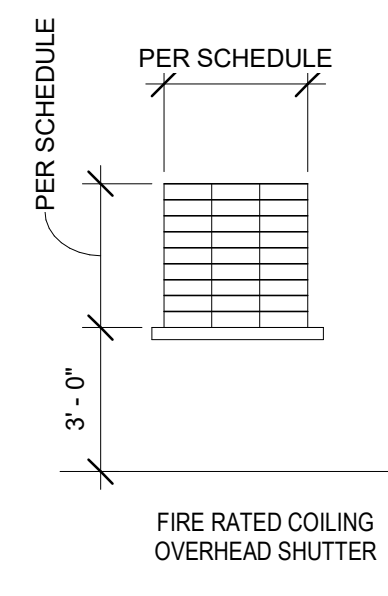
H

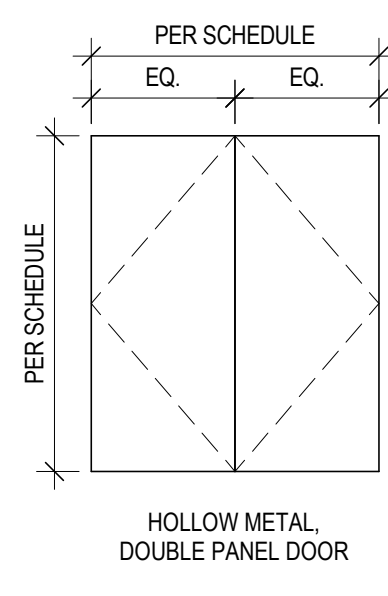

I



J

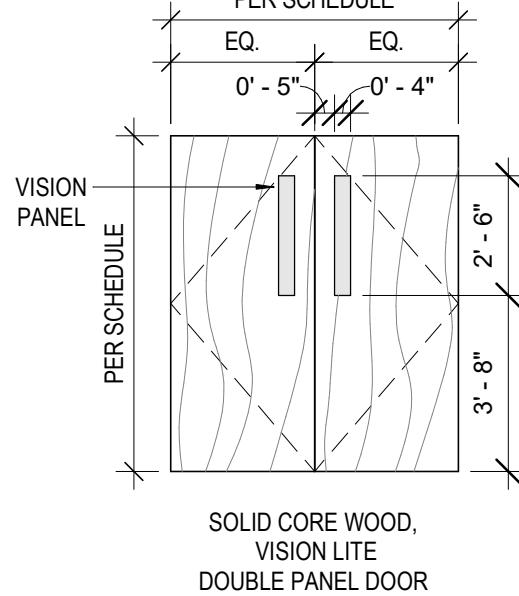

K

Archdiocese of Seattle

St. Andrew Catholic Church Parish Hall

1401 Valley Avenue East

Sumner, WA 98390-2720

Job No.: 1851 Date: 2020-02-07
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WINDOW AND
DOOR TYPES
AND SCHEDULES

A801

Door Schedule												
Door Number	Door					Frame		Fire Rating	Glazing	Hardware Group	Comments	Door Number
	Width	Height	Thickness	Type	Finish	Type	Finish					
101	3'-0"	7'-0"	0'-1 3/4"	D	PNT	1	PNT	--	--	01		101
102	3'-0"	7'-0"	0'-1 3/4"	A	PNT	1	PNT	--	--	02		102
103	3'-0"	7'-0"	0'-1 3/4"	D	PNT	1	PNT	--	--	01		103
105	3'-0"	7'-0"	0'-1 3/4"	B	ST	1	PNT	--	TEMP	03		105
106	3'-0"	7'-0"	0'-1 3/4"	B	ST	1	PNT	--	TEMP	03		106
107	4'-0"	7'-0"	0'-1 3/4"	B	ST	1	PNT	--	TEMP	03		107
108A	6'-0"	8'-0"	0'-2"	J	MFR	ALUM	--	--	1" TEMP	04		108A
108B	6'-0"	8'-0"	0'-2"	J	MFR	ALUM	--	--	1" TEMP	05		108B
110A	6'-0"	8'-0"	0'-2"	J	MFR	ALUM	--	--	1" TEMP	05		110A
110B	6'-0"	8'-0"	0'-2"	J	MFR	ALUM	--	--	1" TEMP	04		110B
111	3'-0"	7'-0"	0'-1 3/4"	D	ST	1	PNT	--	--	06		111
112	3'-0"	7'-0"	0'-1 3/4"	D	ST	1	PNT	--	--	06		112
113	4'-0"	7'-0"	0'-1 3/4"	C	ST	1	PNT	--	TEMP	12		113
114A	3'-0"	7'-0"	0'-1 3/4"	C	ST	1	PNT	45 MIN.	TEMP	07		114A
114B	4'-0"	7'-0"	0'-1 3/4"	C	ST	1	PNT	45 MIN.	TEMP	12		114B
114D	3'-0"	8'-0"	0'-3"	K	MFR	MFR	MFR	60 MIN.	--	13	ALUMINUM COILING OVERHEAD SHUTTER	114D
114E	4'-0"	7'-0"	0'-1 3/4"	A	PNT	1	PNT	--	--	08		114E
115	3'-0"	7'-0"	0'-1 3/4"	D	PNT	1	PNT	--	--	01		115
116A	8'-0"	7'-0"	0'-1 3/4"	F	ST	1	PNT	--	--	09		116A
116B	8'-0"	7'-0"	0'-1 3/4"	F	ST	1	PNT	--	--	09		116B
117A	6'-0"	8'-0"	0'-2"	H	ST	1	PNT	--	TEMP	10		117A
117B	6'-0"	8'-0"	0'-2"	H	ST	1	PNT	--	TEMP	10		117B
117C	6'-0"	7'-0"	0'-1 3/4"	I	PNT	1	PNT	--	TEMP	04		117C
117D	6'-0"	7'-0"	0'-1 3/4"	I	PNT	1	PNT	--	TEMP	04		117D
117E	6'-0"	8'-0"	0'-1 3/4"	E	PNT	1	PNT	--	--	11		117E

RMC ARCHITECTS



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P: 360.676.7733 • F: 360.738.0448 • rmc@rmcarchitects.com


FLOORING	
AF	MULTI-USE ACTIVITY FLOORING
CONC-1	EPOXY COATED CONCRETE SLAB
CONC-2	UNPOLISHED CONCRETE, SEALED
CONC-3	STAINED CONCRETE
CPT-1	CARPET TILES
CPT-2	CARPET TILES
RS	RESILIENT SHEET FLOORING
WOOD	PLYWOOD
WM	WALK OFF MATTING
BASE	
RB	RUBBER BASE
RS	COVE RESILIENT SHEET FLOORING
WALL	
AC	ACOUSTICAL PANELING
FRP	FIBERGLASS REINFORCED PANELS
GWB	GYPSUM WALL BOARD, PAINTED
PLAM	PLASTIC LAMINATE
PNT-1	PAIN 1
PNT-2	PAINT 2
WD	WOOD ACCENT WALL
CEILING	
ACT-1	ACOUSTIC CEILING TILE
ACT-2	CLEANABLE ACOUSTIC CEILING TILE
ACT-3	GLUE ON ACOUSTIC TILES
GWB	GYPSUM WALL BOARD, PAINTED
PNT-1	PAINT 1


Room Finish Schedule										
Number	Name	Floor Finish		Wall	Wall Finish				Ceiling	Comments
		Finish - Floor	Finish - Base		Finish - East	Finish - North	Finish - South	Finish - West		
101	MECH / STORAGE	CONC-2	6" RB	GWB	PNT-1	PNT-1	PNT-1	PNT-1	GWB	
102	RISER	CONC-2	6" RB	GWB	--	--	--	--	GWB	
103	JANITOR	RS	COVE RS	GWB/FRP	PNT-1/MFR	PNT-1/MFR	PNT-1/MFR	PNT-1/MFR	GWB	FRP WALL COVER TO EXTEND 60" AFF, INTEGRAL VINYL COVE BASE
104	HALLWAY	CONC-3	6" RB	GWB	PNT-1	PNT-1	PNT-1	PNT-1	ACT-1	
105	MEETING 1	CPT-1	4" RB	GWB	PNT-1	PNT-2	PNT-1, *	PNT-1	GWB/ACT-1	MOVEABLE WALL PARTITION TO SOUTH
106	MEETING 2	CPT-1	4" RB	GWB	PNT-1	PNT-1, *	PNT-2	PNT-1	GWB/ACT-1	MOVEABLE WALL PARTITION TO NORTH
107	MEETING 3	CPT-2	4" RB	GWB	PNT-1	PNT-2	PNT-1	PNT-1	GWB/ACT-1	
108	VESTIBULE	WM	6" RB	GWB	PNT-1	PNT-1	PNT-1	PNT-1	GWB	
109	HALLWAY	CONC-3	6" RB	GWB/WD	PNT-1/ST	PNT-1/ST	PNT-1/ST	PNT-1/ST	ACT-1	SEE INTERIOR ELEVATIONS FOR WOOD ACCENT WALL DETAILS
110	VESTIBULE	WM	6" RB	GWB	PNT-1	PNT-1	PNT-1	PNT-1	GWB	
111	WOMEN	RS	COVE RS	GWB/PLAM	PNT-1/MFR	PNT-1/MFR	PNT-1/MFR	PNT-1/MFR	GWB	INTEGRAL VINYL COVE BASE, SEE INTERIOR ELEVATIONS FOR EXTENTS OF PLASTIC LAMINATE WALL COVERING
112	MEN	RS	COVE RS	GWB/PLAM	PNT-1/MFR	PNT-1/MFR	PNT-1/MFR	PNT-1/MFR	GWB	INTEGRAL VINYL COVE BASE, SEE INTERIOR ELEVATIONS FOR EXTENTS OF PLASTIC LAMINATE WALL COVERING
113	HALLWAY	CONC-3	6" RB	GWB	PNT-1	PNT-1	PNT-1	PNT-1	ACT-1	
114	KITCHEN	CONC-1	6" RB	FRP	MFR	MFR	MFR	MFR	ACT-2	
115	STORAGE	CONC-1	6" RB	GWB	PNT-1	PNT-1	PNT-1	PNT-1	ACT-2	
116	STORAGE	CONC-2	6" RB	GWB	PNT-1	PNT-1	PNT-1	PNT-1	GWB	SEE INTERIOR ELEVATIONS FOR PLYWOOD WALL PROTECTION AROUND ROOM PERIMETER
117	HALL	AF	6" RB	GWB/PLAM	PNT-1/MFR	PNT-1/MFR	PNT-1/MFR	PNT-1/MFR	GWB/ACT-3	SEE INTERIOR ELEVATIONS FOR EXTENTS OF ACOUSTICAL WALL COVERING AND PLASTIC LAMINATE WALL COVERING, SEE REFLECTED CEILING PLAN FOR CEILING FINISH LAYOUT
201	MECH	WOOD	--	GWB	PNT-1	PNT-1	PNT-1	PNT-1	GWB	

ROOM FINISH NOTES


1. PAINT ALL MECHANICAL GRILLS TO MATCH ADJACENT WALL COLOR.
2. SEE SPEC FOR ADDITIONAL INFORMATION ON FINISHES AND PAINTS.
3. PAINT ALL GWB CEILINGS PNT-1, UNO.
4. PAINT ALL HM DOORS AND FRAMES PER DOOR SCHEDULE.
5. AN " " IN THE FINISH SCHEDULE REFERS TO SEE NOTES IN COMMENTS COLUMN.
6. PROVIDE 48" TALL STAINLESS STEEL CORNER GUARDS PER PLAN LOCATIONS

FLOOR FINISH NOTES




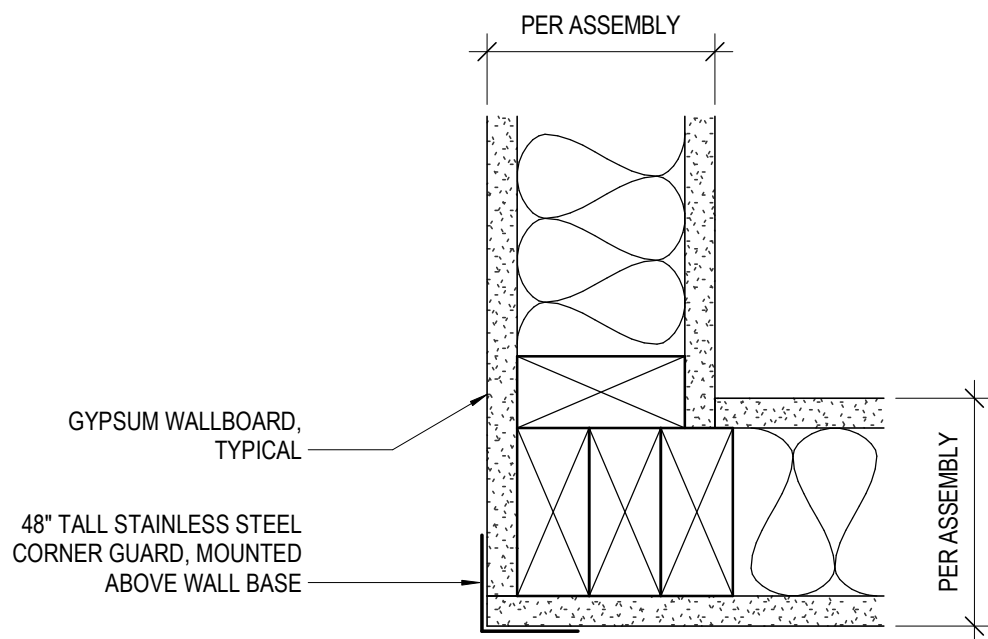

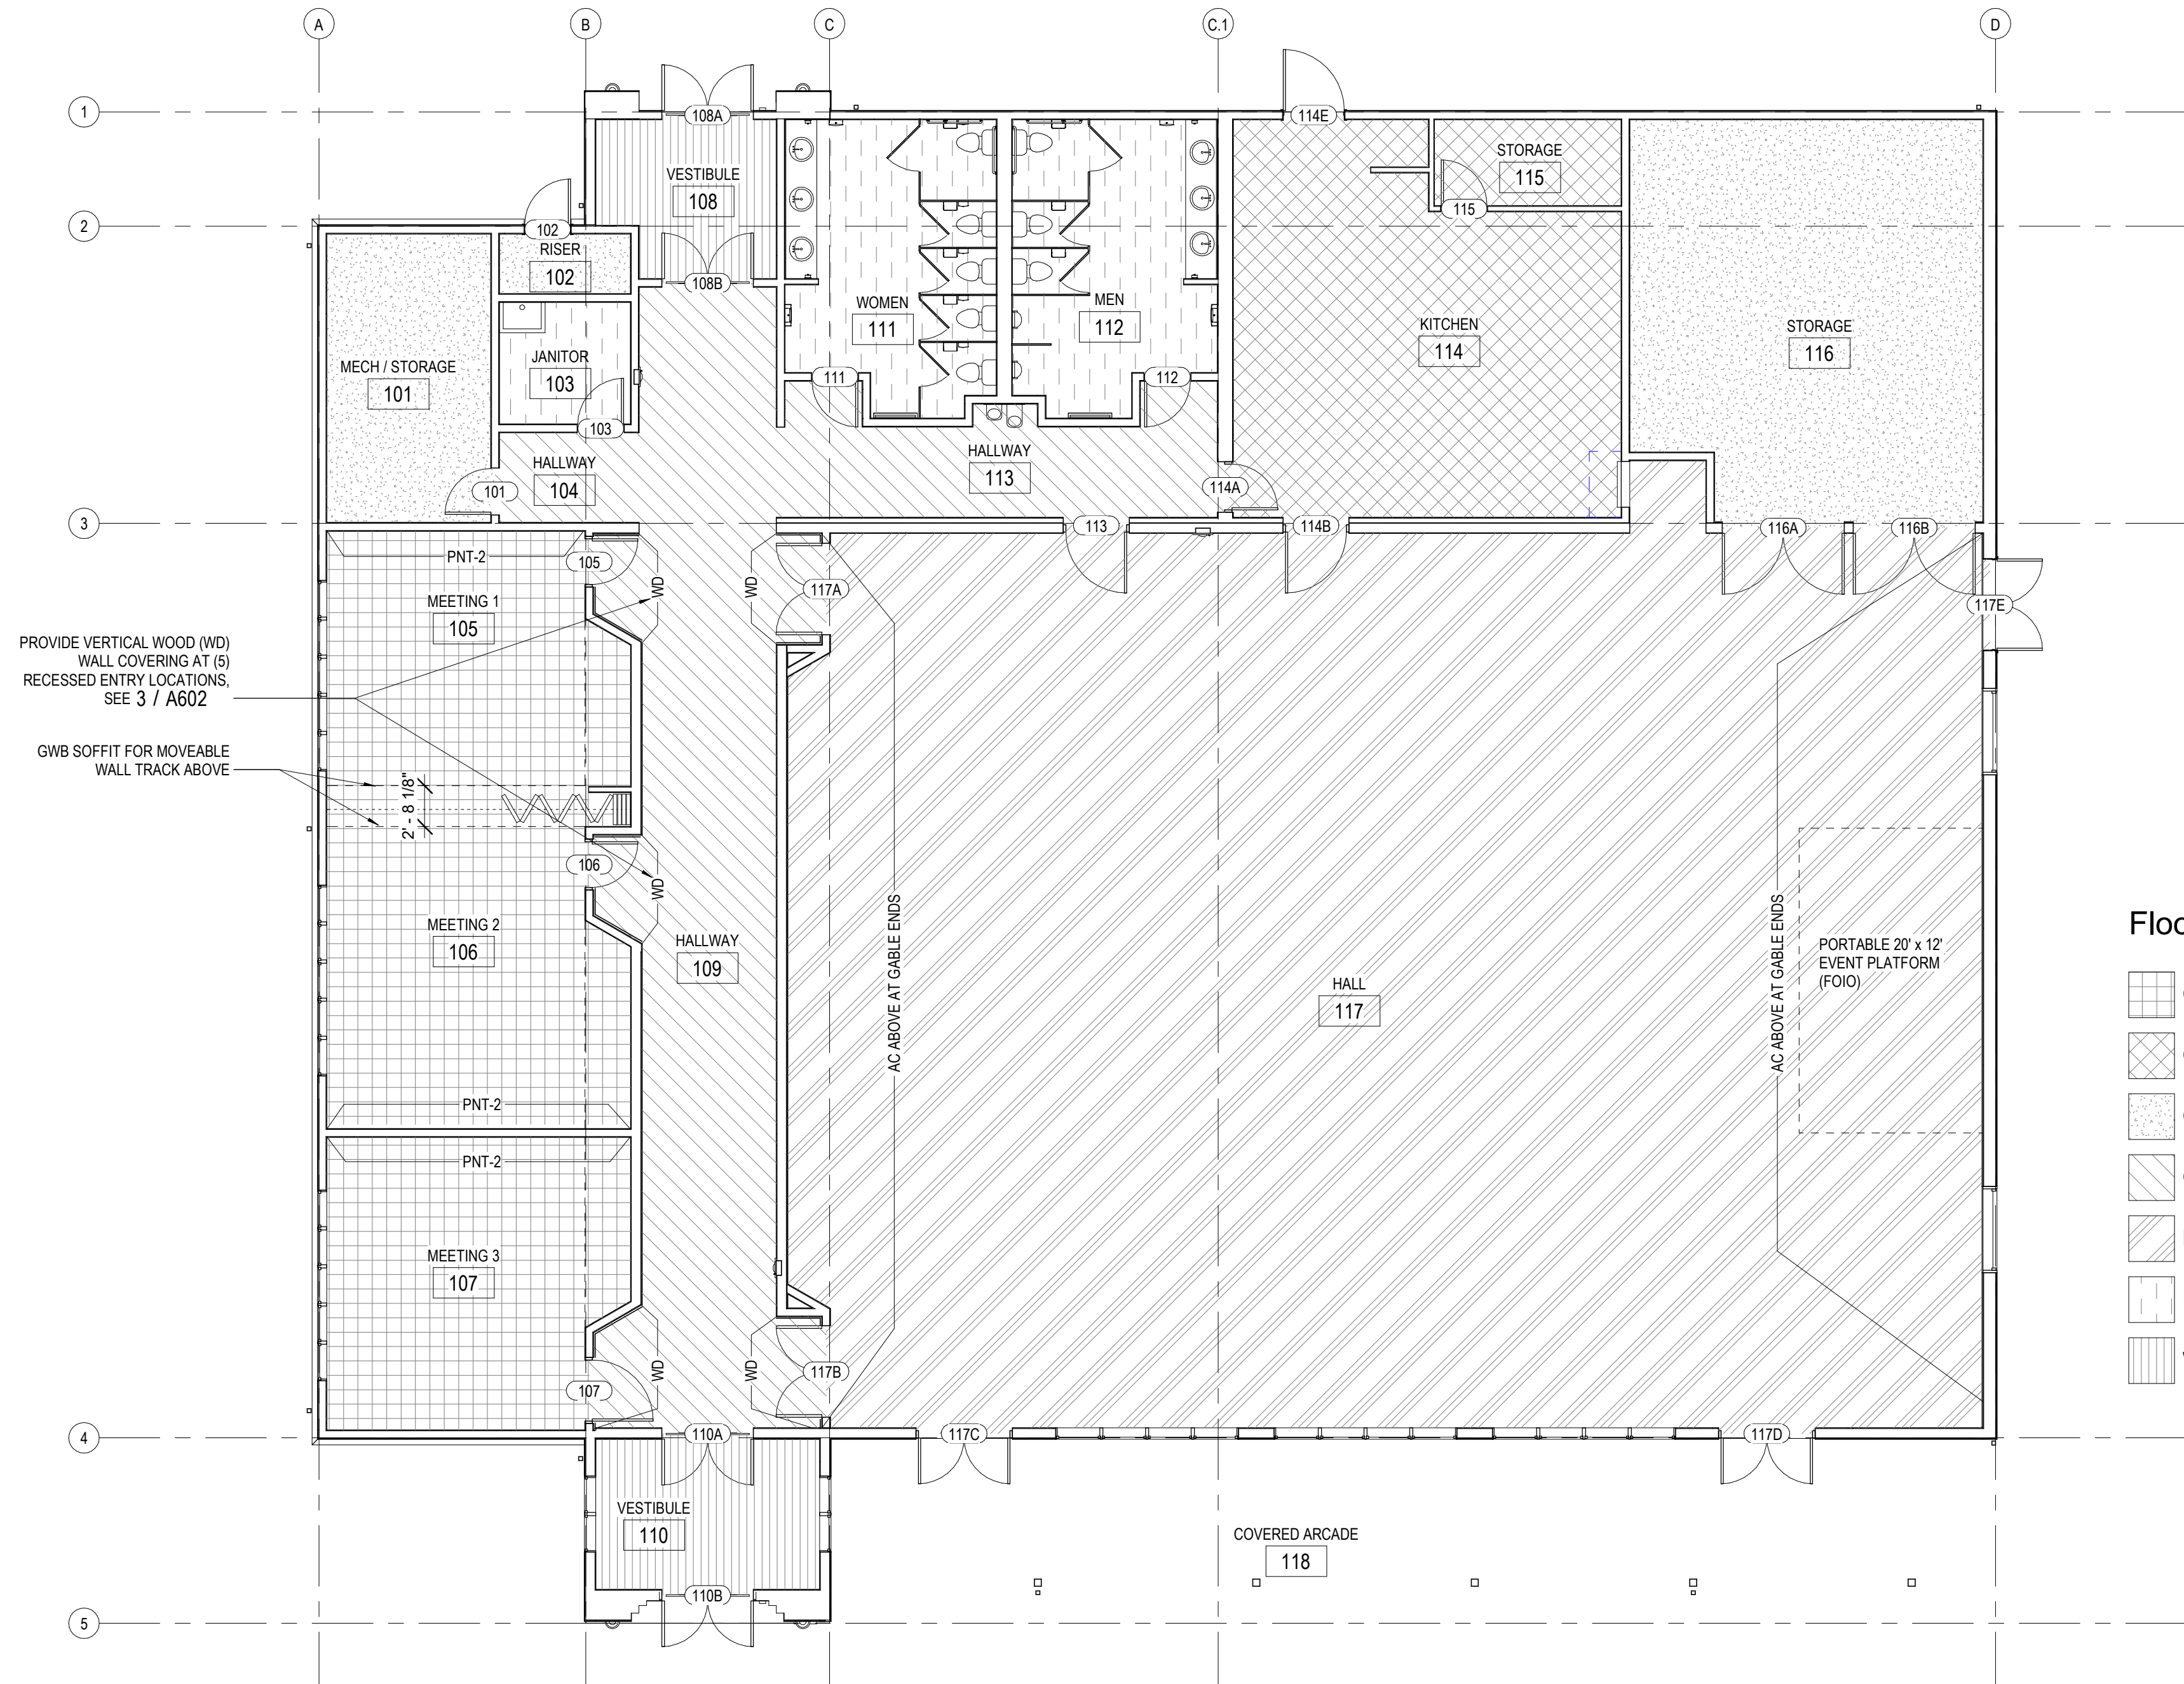

1. SYMBOL  IS TO CLARIFY THE EXTENTS OF MULTIPLE COLORS AND FINISHES, WHERE NOT EXTENTS ARE SHOWN, REFER TO FINISH SCHEDULE.
2. CENTER FLOOR TRANSITIONS UNDER DOORWAYS, TYP.
3. ALL FLOOR TRANSITIONS MUST BE ADA COMPLIANT.

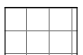

2 Typical Corner Protection
3" = 1'-0"



Floor Finish Legend

-  CARPET-1 OR 2
-  CONC-1 - EPOXY COATED CONCRETE
-  CONC-2 - UNPOLISHED, UNSTAINED CONCRETE
-  CONC-3 - STAINED CONCRETE
-  MULTI-USE FLOORING
-  RESILIENT SHEET FLOORING
-  WALK OFF MAT

1 Finish Plan
1/8" = 1'-0"