



#### **CEILING ASSEMBLIES**

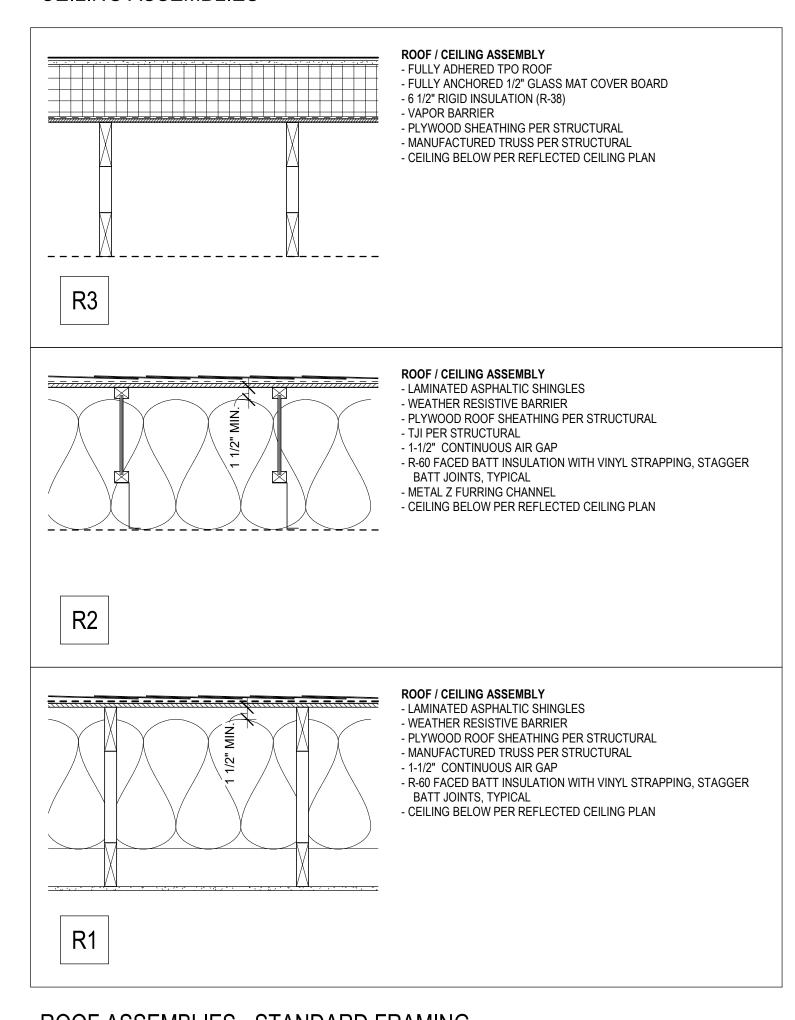


## **ROOF ASSEMBLIES - STANDARD FRAMING**

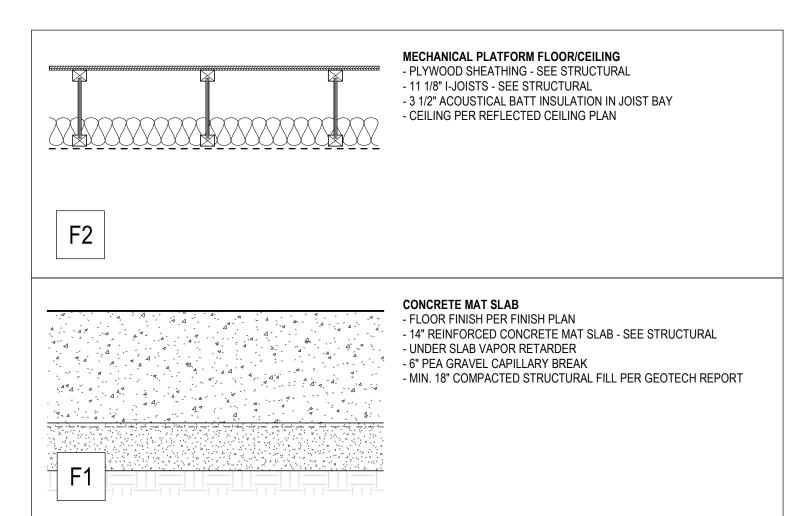

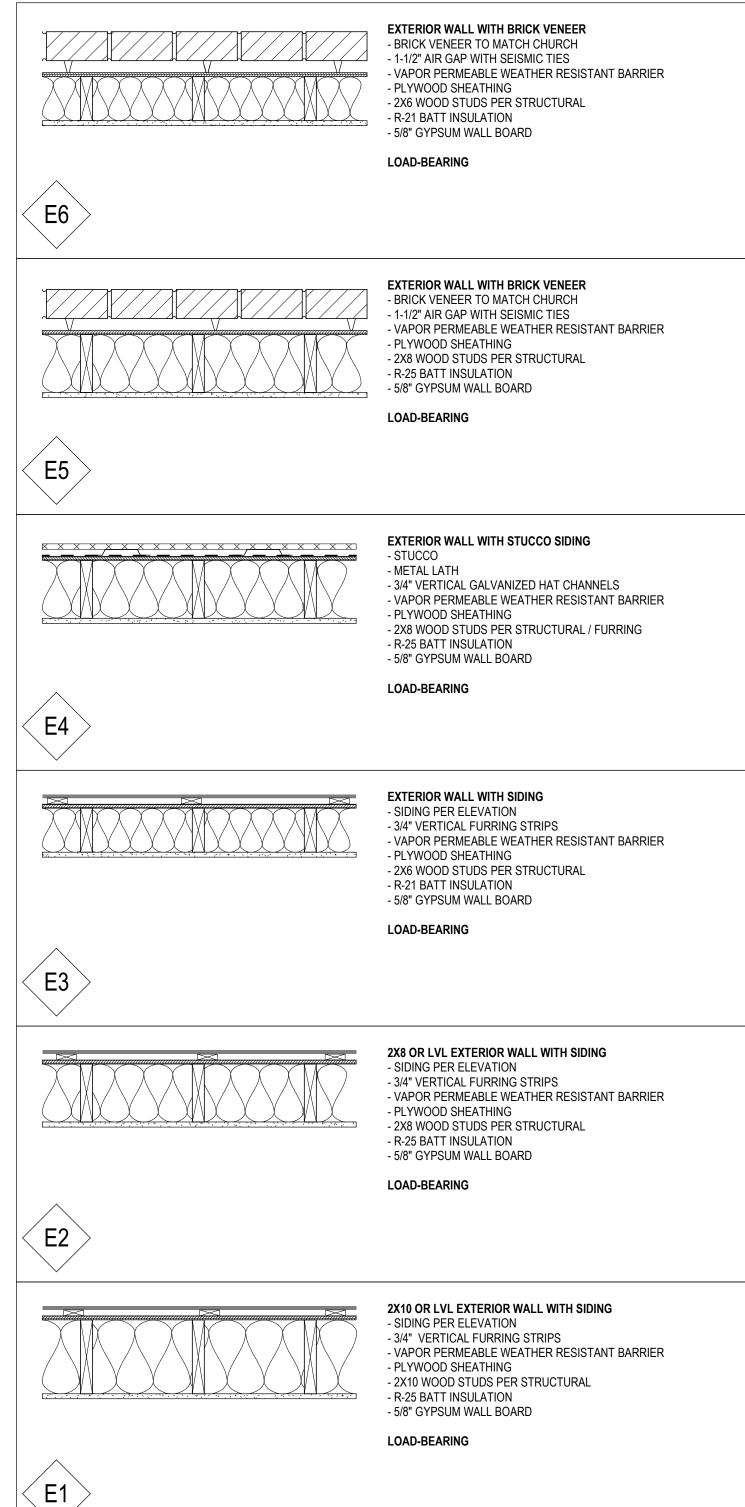

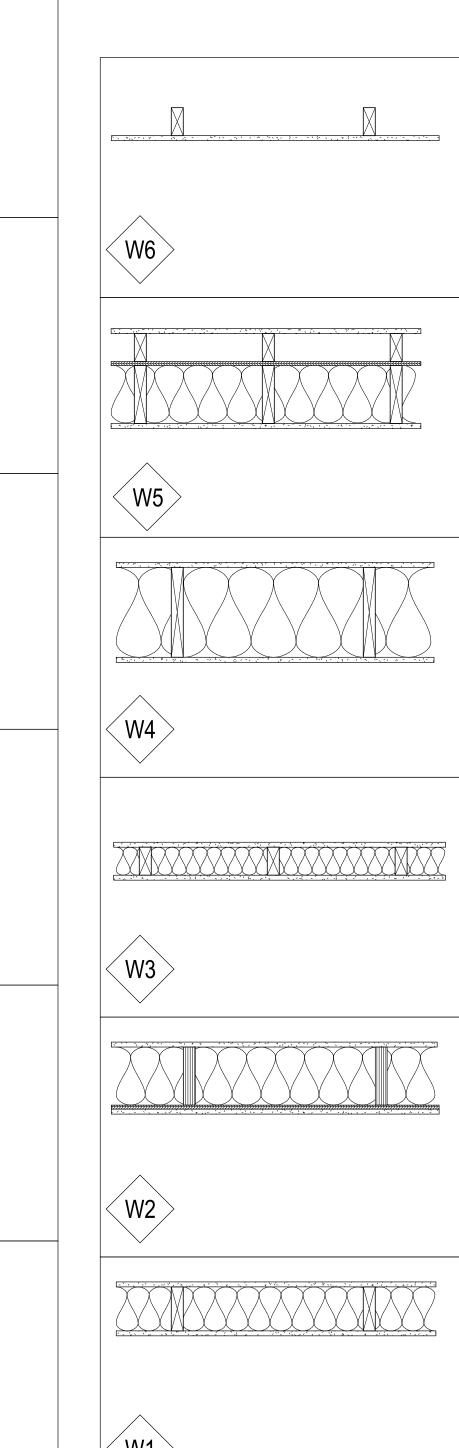

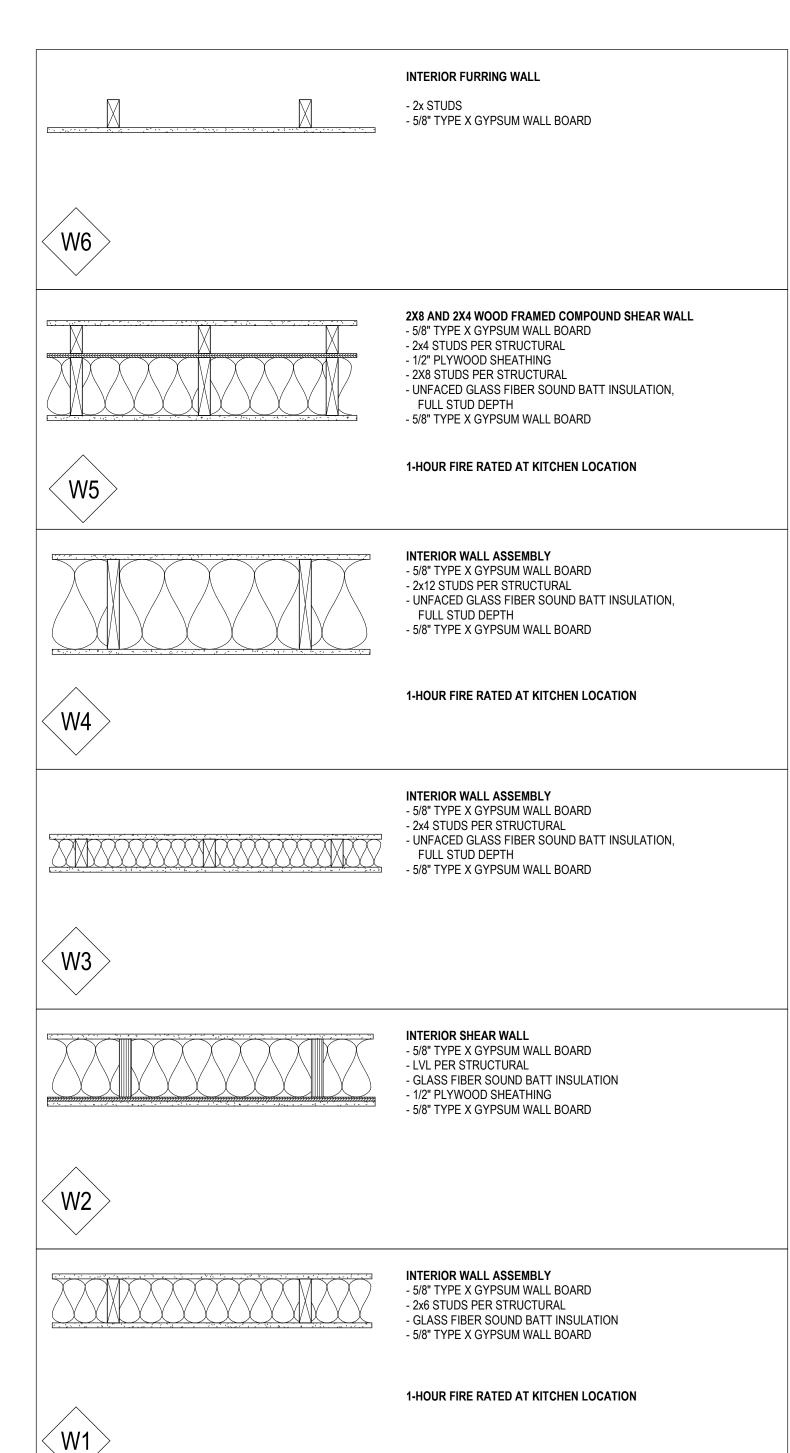

BRADLEY P. CORNWELL STATE OF WASHINGTO

arish Andrew Catholic Church Valley Avenue East Ier, WA 98390-2720 Andrew 1 Valley Aven Archdiocese (St. Andre 1401 Valley Asumner, WA)

Job No: 1851 Date: 2020-02-07 File No: 1851 St. Andrew Parish Hall Drawn By: AMR Checked By: BPC Issued for: PERMIT SET

**ASSEMBLIES** 

EXISTING 15' WATERLINE EASEMENT -

#### SHEET NOTES

REFER TO CIVIL DRAWINGS FOR ADDITIONAL EXISTING SITE ELEMENTS, SITE CONDITIONS, AND PROPOSED NEW IMPROVEMENTS.
 PROTECT ALL EXISTING STRUCTURES AND UTILITIES.

SEE LANDSCAPE DRAWINGS FOR ALL NEW LANDSCAPE AND IRRIGATION IMPROVEMENTS.
 ALL GENERAL NOTES HEREIN APPLY TO ALL TRADES FOR THE PROJECT

AMENDED ELSEWHERE TO INCLUDE ISOLATED CONDITIONS.

5. THE DRAWINGS ARE INTENDED TO SHOW THE GENERAL ARRANGEMENT, DESIGN, AND EXTENT OF THE WORK AND ARE PARTLY DIAGRAMMATIC - THEY ARE NOT INTENDED TO BE SCALED.

6. ALL DETAILS AND SECTIONS SHOWN ON THE DRAWINGS ARE INTENDED TO BE TYPICAL AND SHALL BE CONSIDERED TO APPLY TO ANY SIMILAR SITUATION ELSEWHERE ON THE PROJECT, EXCEPT WHERE A DIFFERENT

DETAIL IS SHOWN.

7. THE CONTRACTOR AND ALL SUBCONTRACTORS SHALL VERIFY ALL GRADE LINES, LEVELS, CONDITIONS, AND DIMENSIONS AT THE JOB SITE AND AS SHOWN ON THE DRAWINGS. THEY SHALL REPORT ANY ERRORS OF INCONSISTENCIES IN THE ABOVE TO THE OWNER / ARCHITECT BEFORE

COMMENCING WORK.

8. THE CONTRACTOR AND ALL SUBCONTRACTORS SHALL LAY OUT THEIR WORK FROM ESTABLISHED REFERENCE POINTS AND BE ESTABLISHED REFERENCE POINTS AND BE RESPONSIBLE FOR ALL LINES, ELEVATIONS, AND MEASUREMENTS IN CONNECTION WITH THEIR OWN SCOPE.

9. PROTECTION

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B. PROVIDE ALL SHORING AND BRACING AS REQUIRED FOR THE PROPER EXECUTION OF THE WORK - REMOVE WHEN WORK IS COMPLETED.
C. PROVIDE AND MAINTAIN SAFETY LIGHTING AND BARRICADES AT ALL AREAS OF WORK ADJACENT TO PUBLIC WAYS OR PUBLIC SPACES.
D. AT ALL TIMES PROVIDE PROTECTION AGAINST WEATHER (RAIN, WIND, STORMS, OR HEAT) SO AS TO MAINTAIN ALL WORK, MATERIALS,

APPARATUS, AND FIXTURES FREE FROM DAMAGE.

E. THE CONTRACTOR SHALL PAY FOR ALL DAMAGES TO ADJACENT STRUCTURES, SIDEWALKS, AND STREETS OR OTHER PUBLIC PROPERTY

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ARCHITE

BRADLEY P. CORNWELL STATE OF WASHINGTON

Archdlocese of Seattle

St. Andrew Catholic Church Parish F

1401 Valley Avenue East

Job No: 1851 Date: 2020-02-07
File No: 1851 St. Andrew Parish Hall
Drawn By: JW, AMR
Checked By: BPC
Issued for: PERMIT SET

EXISTING SITE PLAN

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ARCHITE

RMC Architects, PLLC •1223 Railr P:360.676.7733 • F:360.738.0448

BRADLEY P. GORNWEYLL
STATE OF WASHINGTON

Archdiocese of Seattle

St. Andrew Catholic Church Parish

1401 Valley Avenue East

Job No: 1851 Date: 2020-02-07
File No: 1851 St. Andrew Parish Hall
Drawn By: AMR
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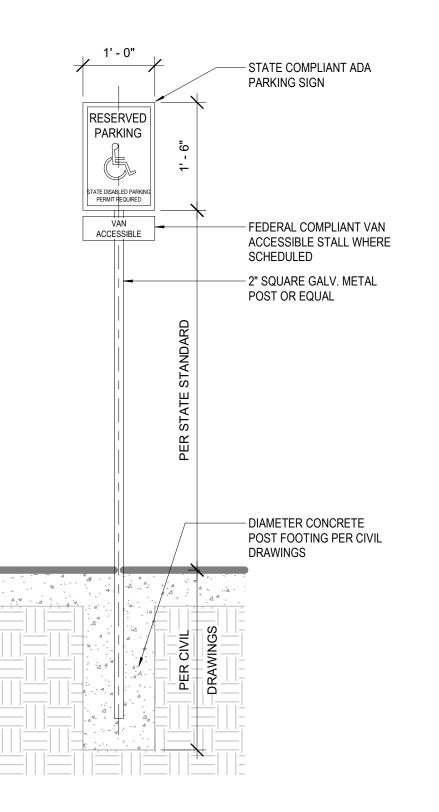
SITE PLAN




MANUFACTURER: URBAN RACKS MODEL: URBAN STAPLE - UB-1000-STD

INSTALLATION: SURFACE MOUNT


FINISH: GALVANIZED



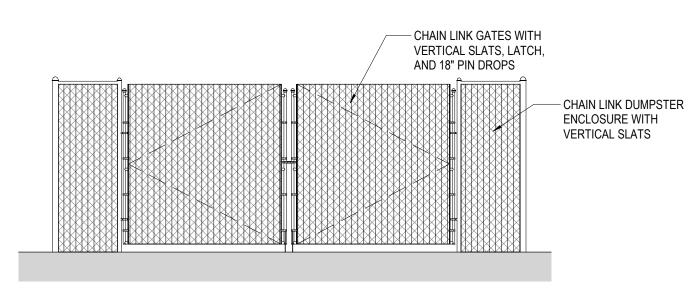


Dumpster Enclosure South

1/4" = 1'-0"

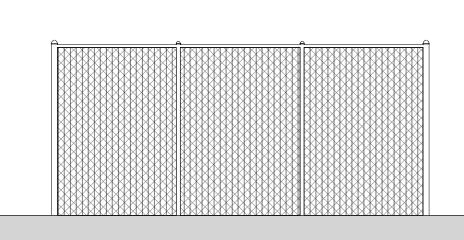

Dumpster Enclosure West (EAST SIM.)

1/4" = 1'-0"

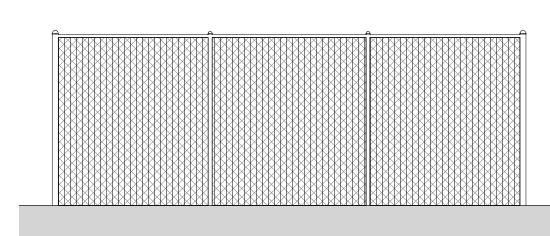

2 Dumpster Enclosure North

1/4" = 1'-0"

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SHEET NOTES

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6. SEE SPECIFICATIONS FOR ALL FOIO ITEMS, TYPICAL. 7. THE DRAWINGS ARE INTENDED TO SHOW THE GENERAL ARRANGEMENT, DESIGN, AND EXTENT OF THE WORK AND ARE PARTLY DIAGRAMMATIC - THEY ARE NOT INTENDED TO BE SCALED.

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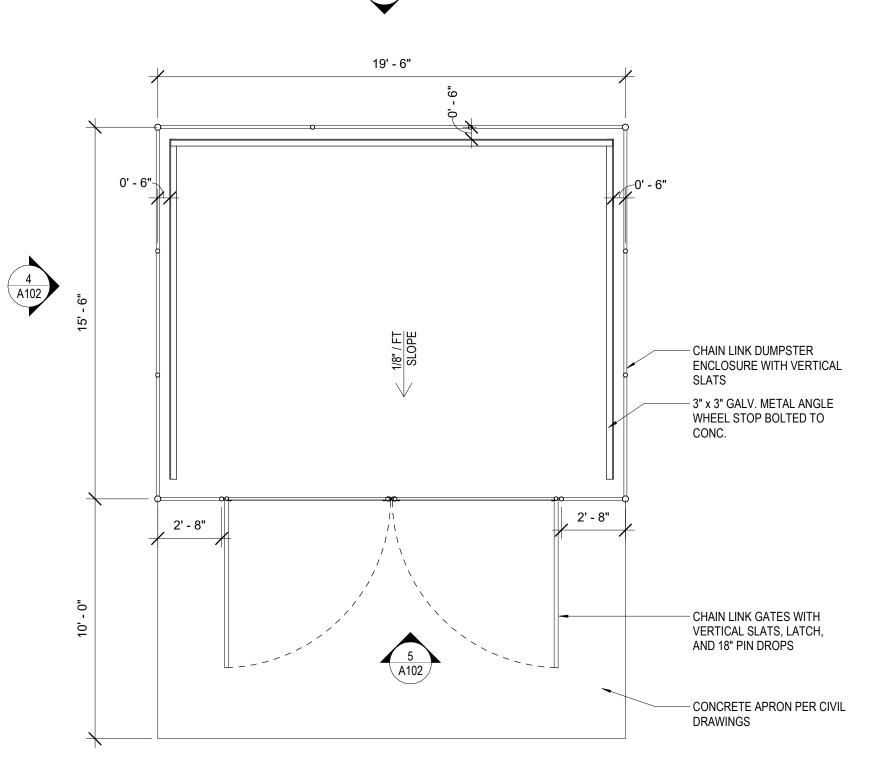
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Dumpster Enclosure

1/4" = 1'-0"

1/4" = 1'-0"



**Q** 

~

6979 REGISTERED

STATE OF WASHINGTON

BRADLEY P. CORNWELL

Job No: 1851 Date: 2020-02-07 File No: 1851 St. Andrew Parish Hall Drawn By: AMR Checked By: BPC Issued for: PERMIT SET

SITE DETAILS

Level 1

1/8" = 1'-0"

#### SHEET NOTES

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ARCHITI




Archdlocese of Seattle

St. Andrew Catholic Church Paris
1401 Valley Avenue East
Sumner, WA 98390-2720

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<u>Job No: 18</u>	51	Date: 2020-02-07
File No:	1851	St. Andrew Parish I
Drawn By:	AMR	
Checked By	:BPC	
Issued for:	PERN	MIT SET

FLOOR PLAN

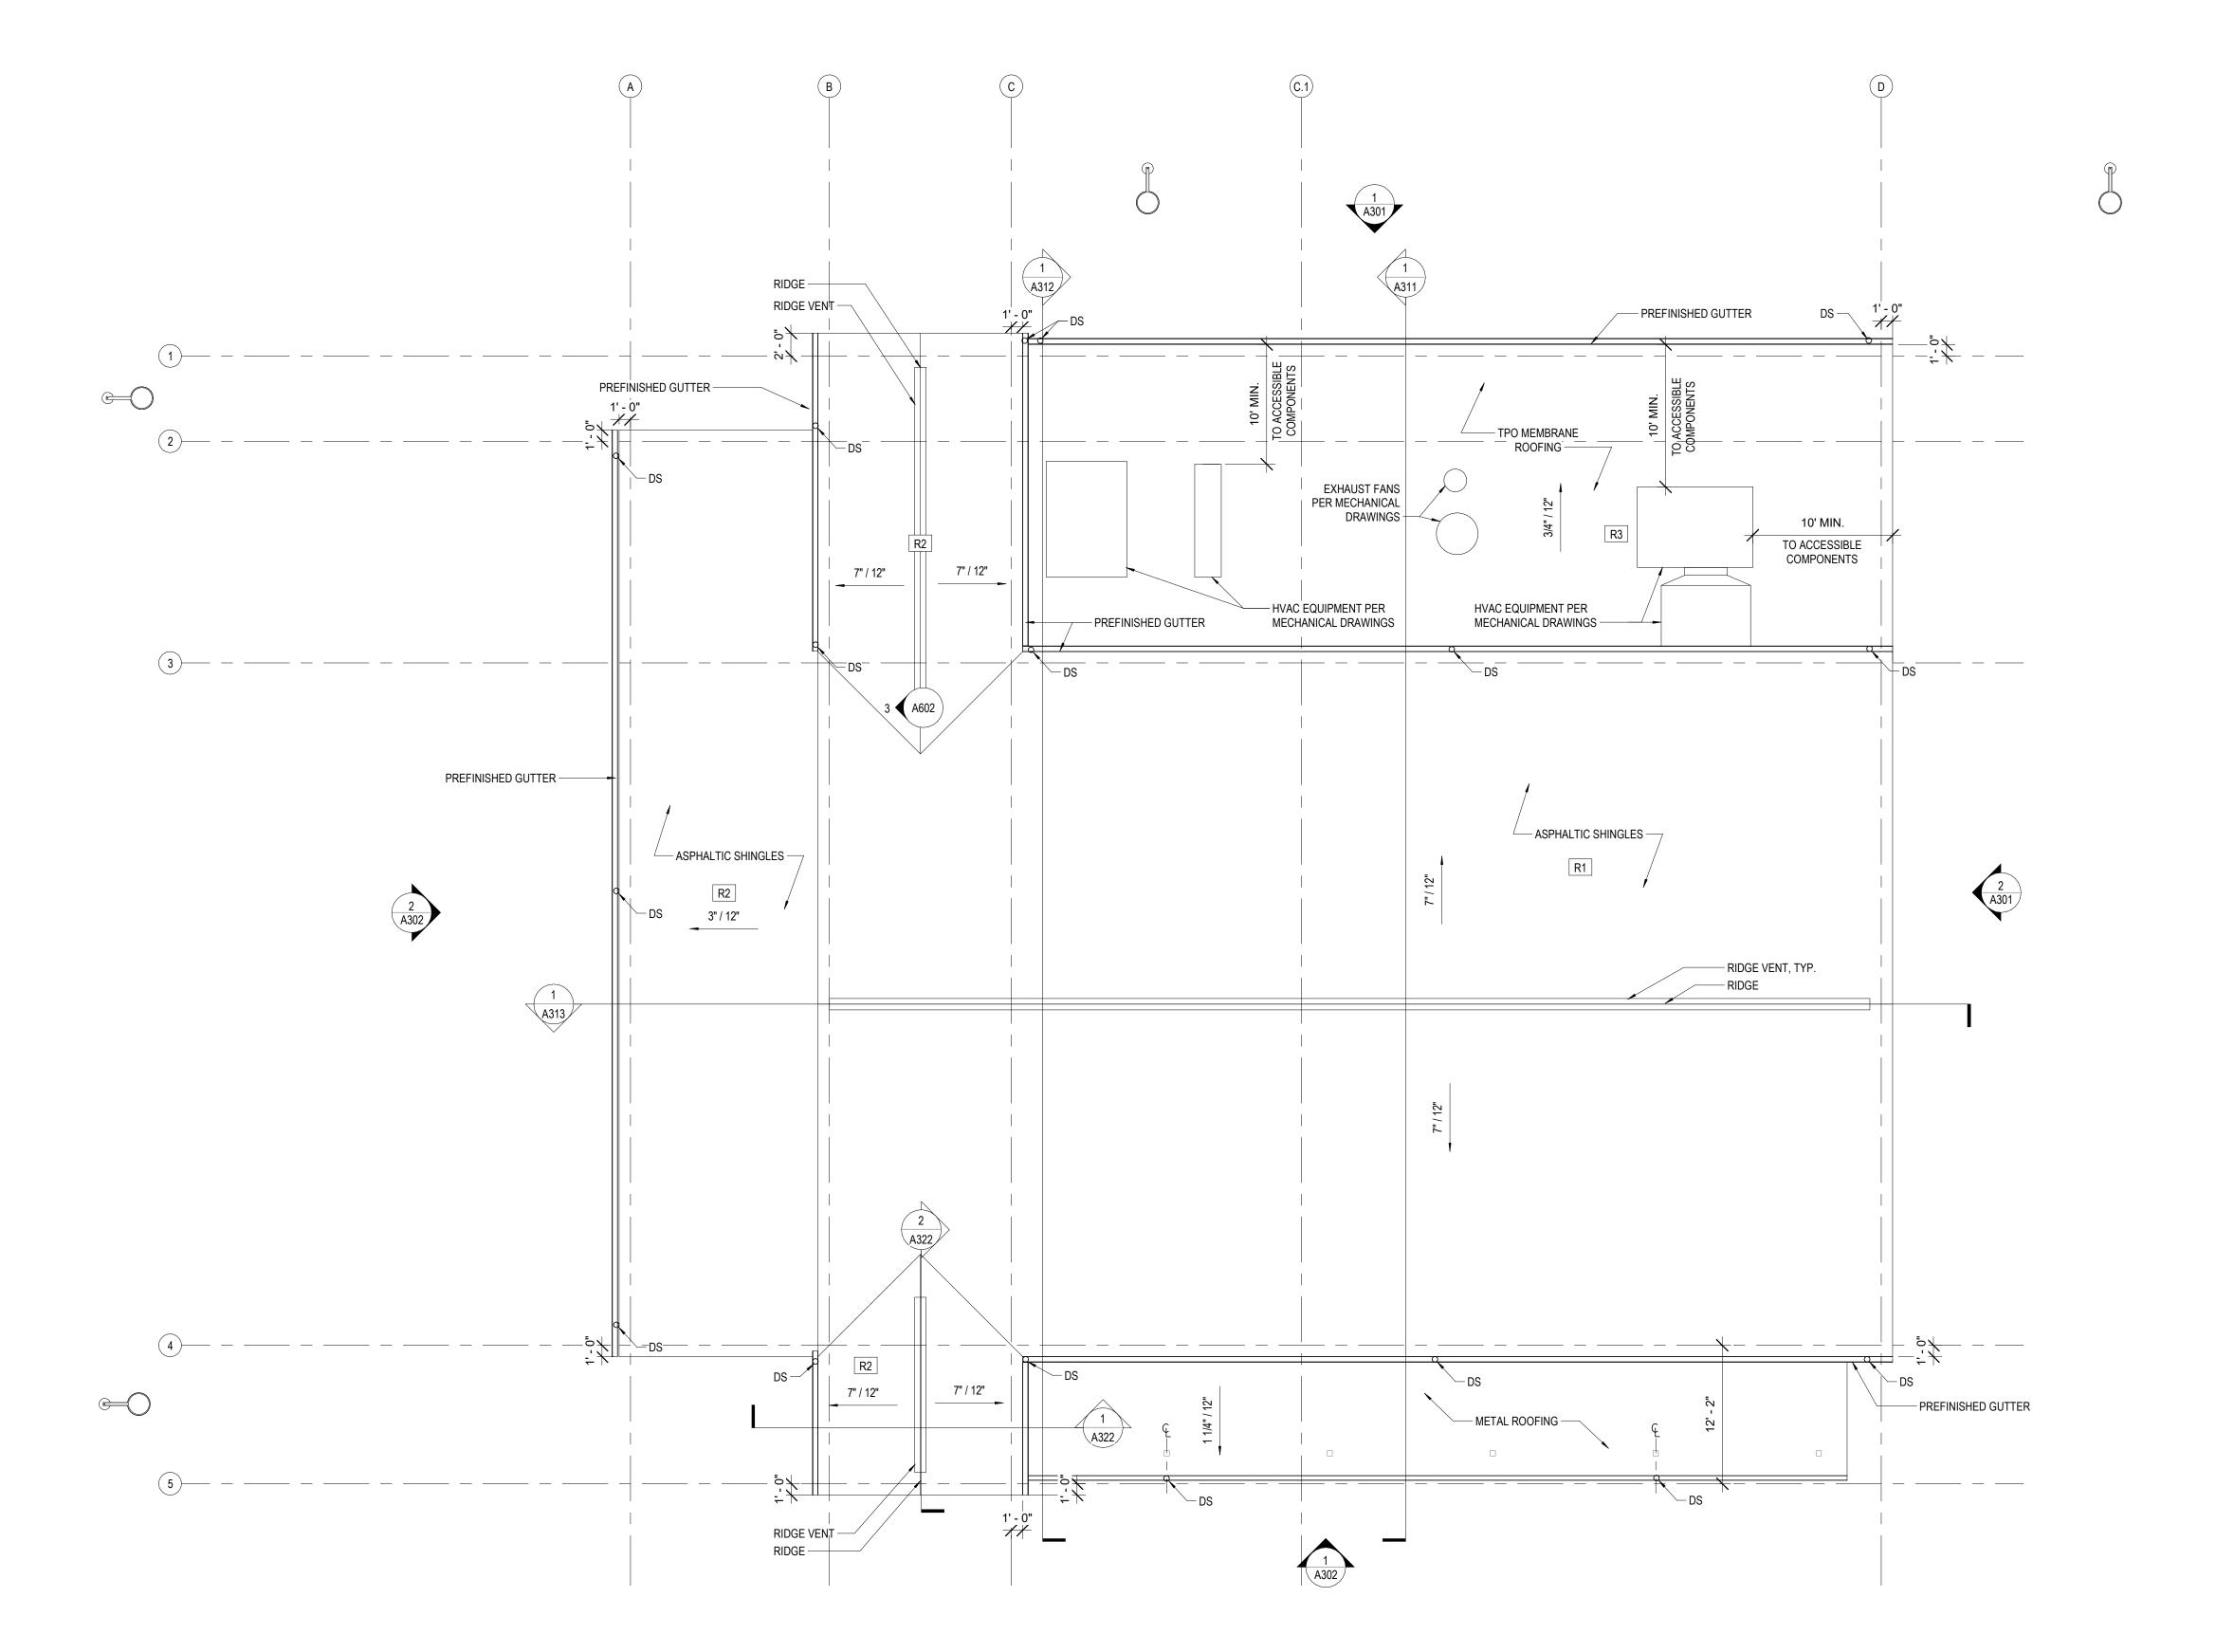





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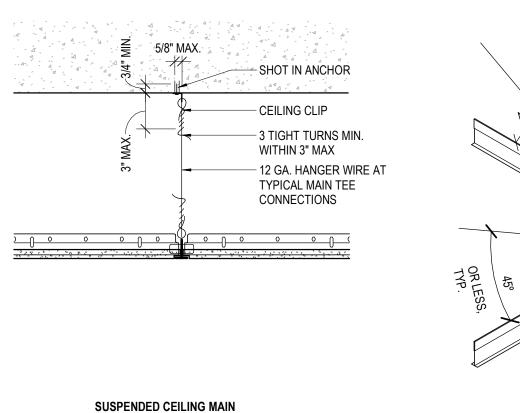


Archdiocese of Seattle


St. Andrew Catholic Church Pari

Job No: 18	51	Date: 2020-02-07
File No:	1851	St. Andrew Parish Ha
Drawn By:	AMR	
Issued for:	PERI	MIT SET
	File No: Drawn By: Checked By	Job No: 1851 File No: 1851 Drawn By: AMR Checked By: BPC Issued for: PERI


**ROOF PLAN** 



TEE HANGER AT 4'-0" O.C.

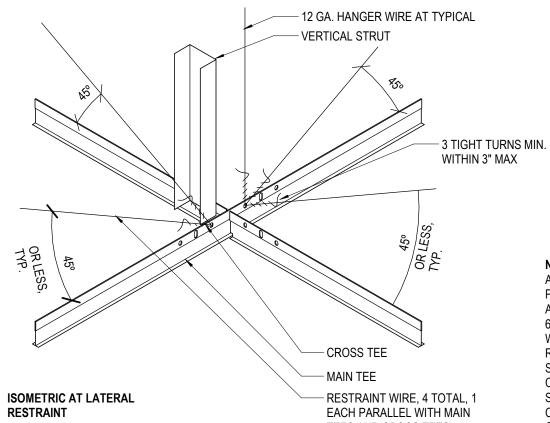

NOTE:
ALL NEW SUSPENDED CEILINGS ARE TO BE CONSTRUCTED
PER IBC VERTICAL AND LATERAL RESTRAINT REQUIREMENTS
AND ASCE 7-10 13.5.6.2.2 AND THE APPLICABLE ASTM (ASTM C
635, ASTM C 636, ASTM E 580/E 580M) AND CISCA STANDARDS.
WHERE IBC, ASCE, ASTM, AND CISCA STANDARDS AND
REQUIREMENTS CONFLICT WITH THE DRAWINGS THE NOTED
STANDARDS AND REQUIREMENTS SHALL GOVERN.
CONTRACTOR IS TO VERIFY ALL REQUIREMENTS. REFERENCE
STANDARDS PER HIERARCHY: IBC, ASCE, ASTM, CISCA.
CONSULT NWCB TECHNICAL DOCUMENT 401 "SUSPENDED
CEILINGS" FOR ADDITIONAL INFORMATION.

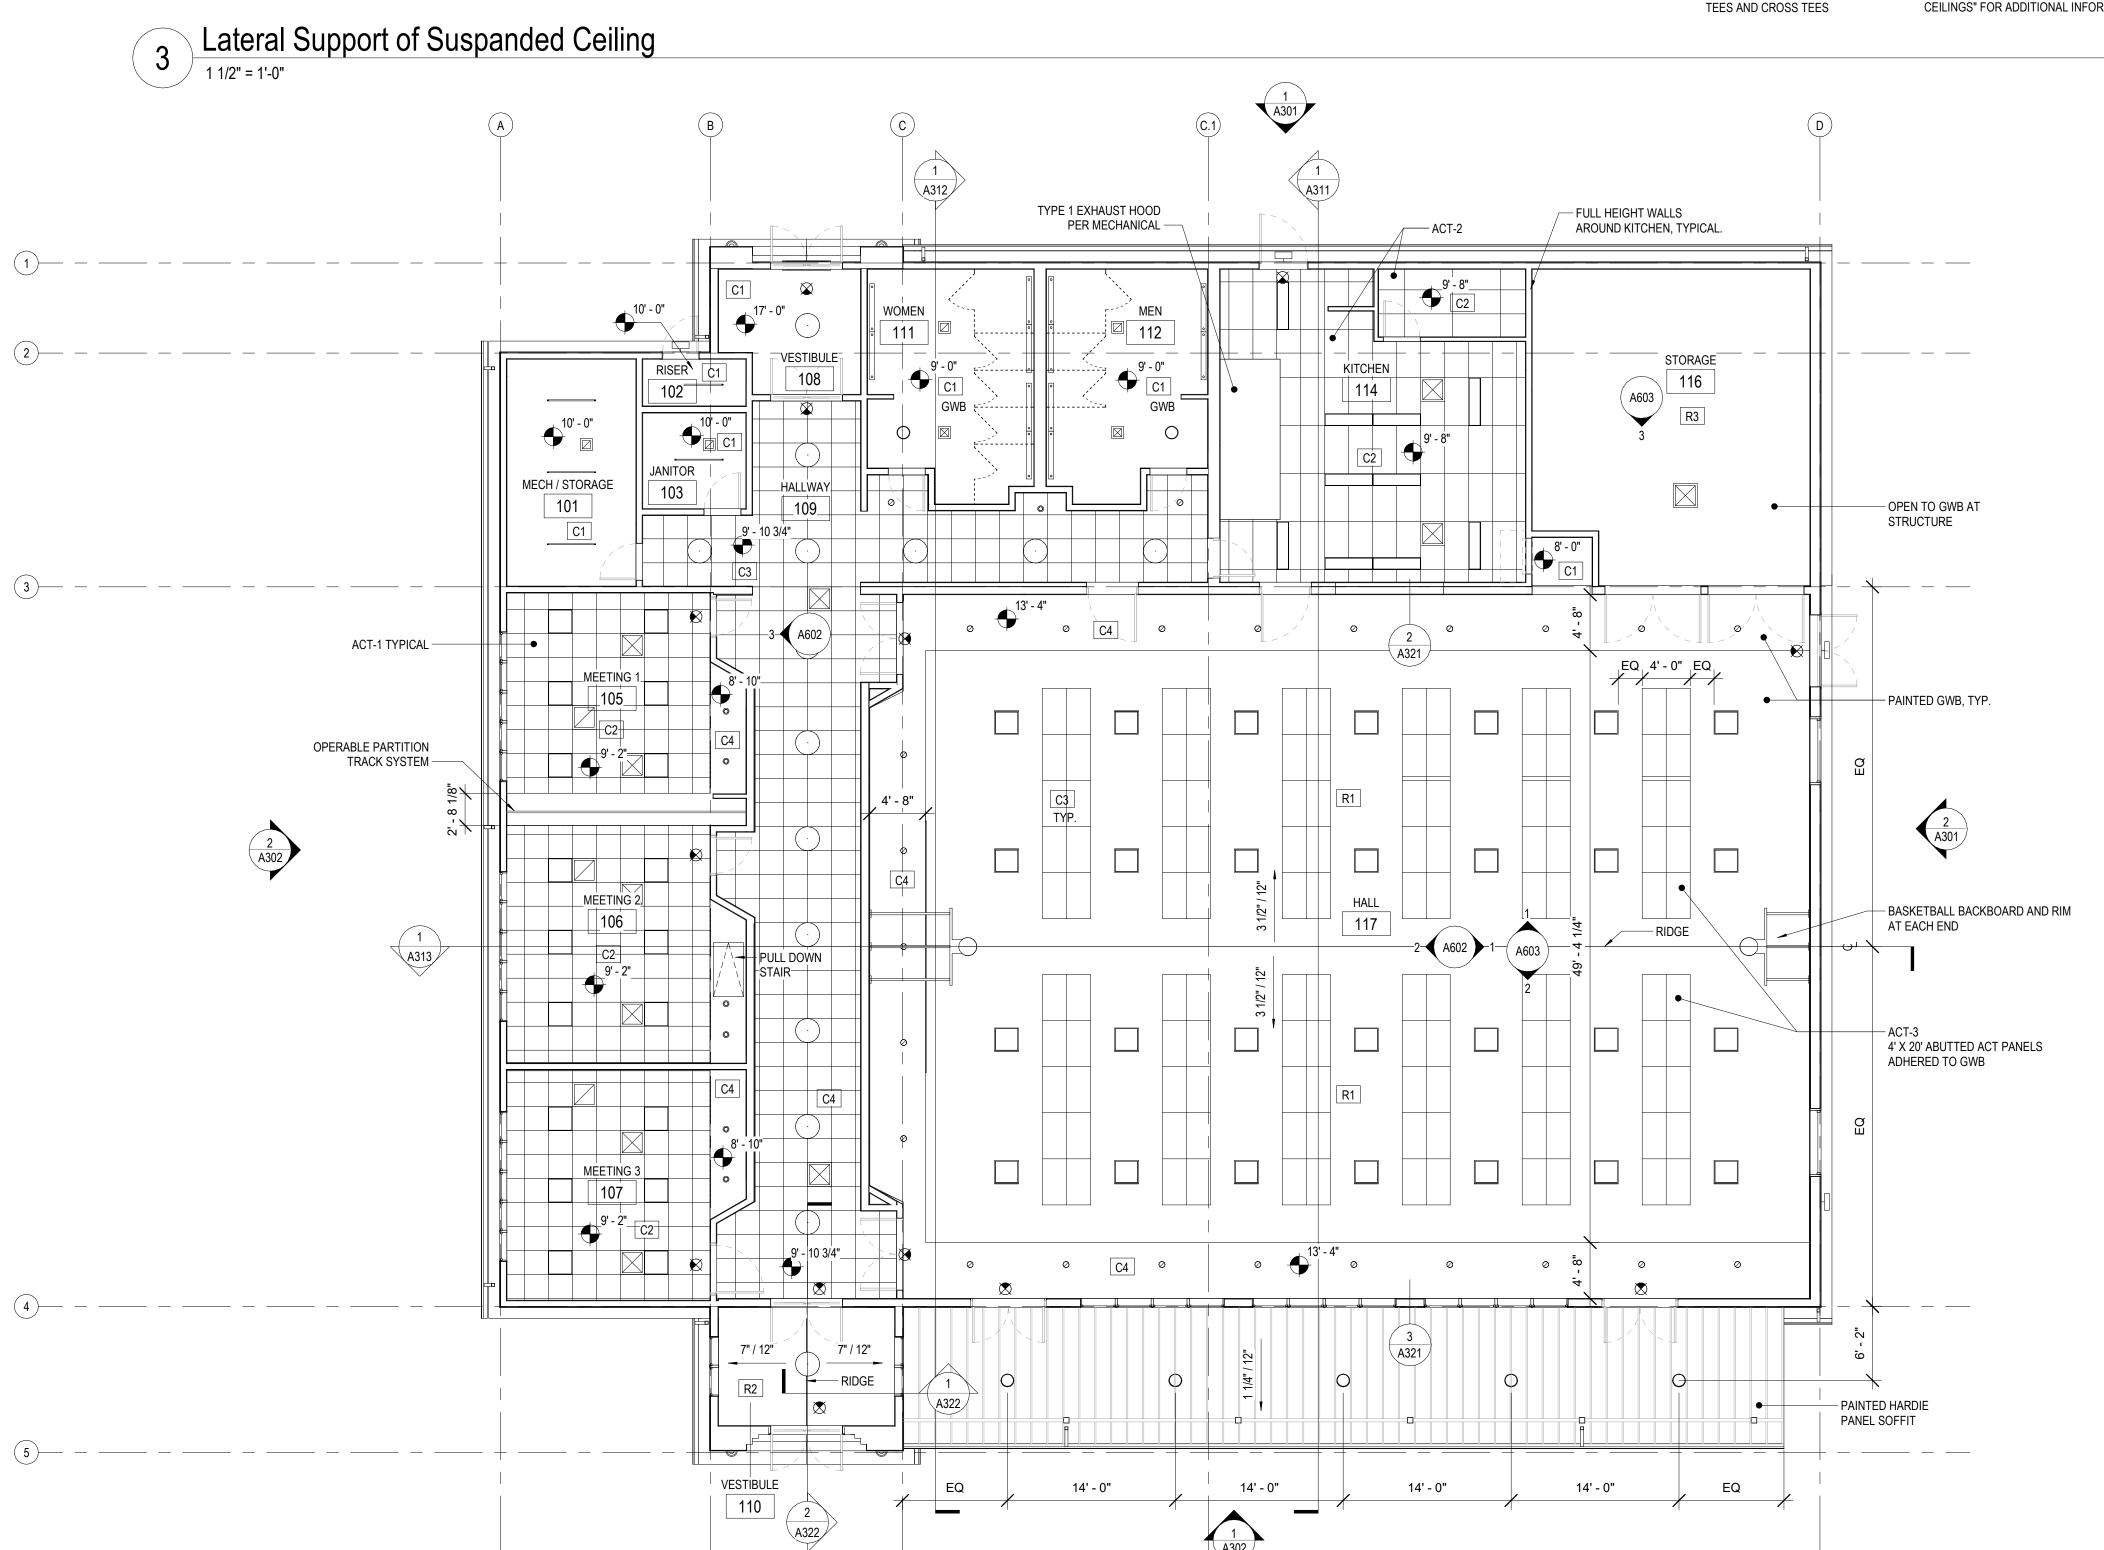

Reflected Ceiling Plan

1/8" = 1'-0"

1/8" = 1'-0"

1/8" = 1'-0"



#### SHEET NOTES

1. DIMENSIONS SHOWN ARE FROM FACE OF STRUCTURE, TYPICAL, UNLESS NOTED OTHERWISE. SEE ASSEMBLIES FOR ADDITIONAL INFORMATION.

2. PROVIDE WALL BACKING AT LOCATIONS PER PLAN, ENLARGED PLANS, AND INTERIOR ELEVATIONS, TYPICAL AT ALL CASEWORK AND WALL MOUNTED ITEMS. CONTRACTOR TO COORDINATE LOCATIONS AND EXTENTS OF WALL BACKING WITH PLANS, ENLARGED PLANS, AND INTERIOR ELEVATIONS.

3. PROVIDE FIRE CAULKING AND FIRE STOPPING AT PENETRATIONS IN FIRE RESISTANCE RATED ASSEMBLES.

4. PROVIDE STAINLESS STEEL 'C' OR 'U' CORNER GUARDS, EXTEND 48" ABOVE FINISHED FLOOR, TYPICAL.

5. SEE CIVIL FOR ALL EXTERIOR PAVING, WALKS, CURBS, APRONS, AND GRADING

6. SEE SPECIFICATIONS FOR ALL FOIO ITEMS, TYPICAL.
7. THE DRAWINGS ARE INTENDED TO SHOW THE GENERAL ARRANGEMENT,
DESIGN, AND EXTENT OF THE WORK AND ARE PARTLY DIAGRAMMATIC - THEY
ARE NOT INTENDED TO BE SCALED.

8. ALL DETAILS AND SECTIONS SHOWN ON THE DRAWINGS ARE INTENDED TO BE TYPICAL AND SHALL BE CONSIDERED TO APPLY TO ANY SIMILAR SITUATION ELSEWHERE ON THE PROJECT, EXCEPT WHERE A DIFFERENT DETAIL IS SHOWN.

9. THE CONTRACTOR AND ALL SUBCONTRACTORS SHALL VERIFY ALL GRADE LINES, LEVELS, CONDITIONS, AND DIMENSIONS AT THE JOB SITE AND AS SHOWN ON THE DRAWINGS. THEY SHALL REPORT ANY ERRORS OF INCONSISTENCIES IN THE ABOVE TO THE OWNER / ARCHITECT BEFORE COMMENCING WORK.

10. THE CONTRACTOR AND ALL SUBCONTRACTORS SHALL LAY OUT THEIR WORK FROM ESTABLISHED REFERENCE POINTS AND BE ESTABLISHED REFERENCE POINTS AND BE RESPONSIBLE FOR ALL LINES, ELEVATIONS, AND MEASUREMENTS IN CONNECTION WITH THEIR OWN SCOPE.

11. PROTECTION

A. THE CONTRACTOR IS RESPONSIBLE AND SHALL COMPLY WITH THE REQUIREMENTS OF THE BUILDING CODE HAVING JURISDICTION AND ALL LOCAL, STATE, AND FEDERAL LAWS.

B. PROVIDE ALL SHORING AND BRACING AS REQUIRED FOR THE PROPER EXECUTION OF THE WORK - REMOVE WHEN WORK IS COMPLETED.
C. PROVIDE AND MAINTAIN SAFETY LIGHTING AND BARRICADES AT ALL AREAS OF WORK ADJACENT TO PUBLIC WAYS OR PUBLIC SPACES.
D. AT ALL TIMES PROVIDE PROTECTION AGAINST WEATHER (RAIN, WIND, STORMS, OR HEAT) SO AS TO MAINTAIN ALL WORK, MATERIALS, APPARATUS, AND FIXTURES FREE FROM DAMAGE.

E. THE CONTRACTOR SHALL PAY FOR ALL DAMAGES TO ADJACENT STRUCTURES, SIDEWALKS, AND STREETS OR OTHER PUBLIC PROPERTY OR TO ANY PUBLIC UTILITIES

OR TO ANY PUBLIC UTILITIES. 12. IF ANY UNCERTAINTIES APPEAR IN THE DRAWINGS, SPECIFICATIONS, OR OTHER DOCUMENTS, THE CONTRACTOR SHALL NOTIFY THE PROJECT MGR. ARCHITECT IN WRITING OF SUCH ITEMS PRIOR TO PROCEEDING WITH ANY WORK WHICH APPEARS IN QUESTION. IN THE EVENT OF THE CONTRACTOR'S FAILING TO GIVE SUCH NOTICE, THEY SHALL BE HELD RESPONSIBLE FOR THE RESULTS OF ANY SUCH OMISSIONS AND THE COST OF RECTIFYING THE SAME. THE CONTRACTOR SHALL HAVE ALL ITEMS OR DETAILS CLARIFIED WITH THE PROJECT MGR. / ARCHITECT PRIOR TO SUBMITTING A BID; OTHERWISE THE ARCHITECT'S INTERPRETATION SHALL BE FINAL. 13. THE CONTRACTOR SHALL USE THE VENDOR / STRUCTURAL DRAWINGS TOGETHER WITH THE ARCHITECTURAL, MECHANICAL, AND ELECTRICAL DRAWINGS TO LOCATE DEPRESSED SLABS, SLOPES, DRAINS, OUTLETS, RECESSES, OPENINGS, REGLETS, BOLT SETTINGS, SLEEVES, DIMENSIONS, ETC. POTENTIAL CONFLICTS SHALL BE TRANSMITTED TO THE ARCHITECT BEFORE PROCEEDING WITH THE WORK. 14. SOME CONNECTIONS INDICATED IN THE DRAWINGS ARE SCHEMATIC,

14. SOME CONNECTIONS INDICATED IN THE DRAWINGS ARE SCHEMATIC,
SECURE ALL COMPONENTS RIGIDLY TO STRUCTURE AND EACH OTHER. USE
FASTENERS DESIGNED FOR EACH INSERVICE CONNECTION
15. OBTAIN CLARIFICATION AND INTERPRETATION OF DRAWINGS AND
SPECIFICATIONS, INCLUDING ADDITIONAL DETAIL, DIRECTLY FROM
ARCHITECT / PROJECT MANAGER.

ARCHITECT / PROJECT MANAGER.

16. WASTE MATERIAL AND RUBBISH FROM DEMOLITION AND ALTERNATIONS SHALL BE REMOVED FROM SITE AS RAPIDLY AS POSSIBLE AND SHALL NOT BE ALLOWED TO ACCUMULATE ON PREMISES. DISPOSAL OF MATERIALS WILL BE AT THE DISCRETION OF THE CONTRACTOR. CONTRACTOR SHALL PROVIDE AN EXTERIOR AREA TO COLLECT ALL DEMOLISHED MATERIAL NOT TO BE REUSED. THE AREA SHALL BE SAFE AND UNOBSTRUCTING THE BUILDING FUNCTION AND THE OWNER'S DAILY BUSINESS OPERATIONS.

RCP	Leaend

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	WALL SCONCE
	EXIT FIXTURE
	SURFACE MOUNT
<b>○</b> >	RECESSED WALL WASHER
	LED OR XENON STRIP
	TRACK LIGHT
<b>─</b>	EXTERIOR SCONCE
	PENDANT LARGE
	PENDANT MEDIUM
<b>o o</b> >	PENDANT SMALL, DIRECTIONAL
	CEILING FAN, PENDANT STEM HUNG

EMERGENCY EXIT LIGHTING AND

SIGNAGE



ARCHI

BRADLEY P. CORNWELL STATE OF WASHINGTON

Archdiocese of Seattle

St. Andrew Catholic Church P
1401 Valley Avenue East
Sumner, WA 98390-2720

Job No: 1851 Date: 2020-02-07
File No: 1851 St. Andrew Parish Hall
Drawn By: AMR
Checked By: BPC
Issued for: PERMIT SET

REFLECTED CEILING PLAN

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STUCCO, WITH CONTROL JOINTS PER ELEVATION

COMPOSITE BOARD AND BATTEN SIDING

SMOOTH HARDIE PANELING WITH CONTROL JOINTS PER ELEVATION

COMPOSITE LAP SIDING

BRICK VENEER


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Archdiocese of Seattle


St. Andrew Catholic Church Paris
1401 Valley Avenue East
Sumner, WA 98390-2720


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Drawn By:			
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Issued for:	_PERM	III SET	
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Enlarged South Entrance Elevation

1/4" = 1'-0" 0 4 4 8




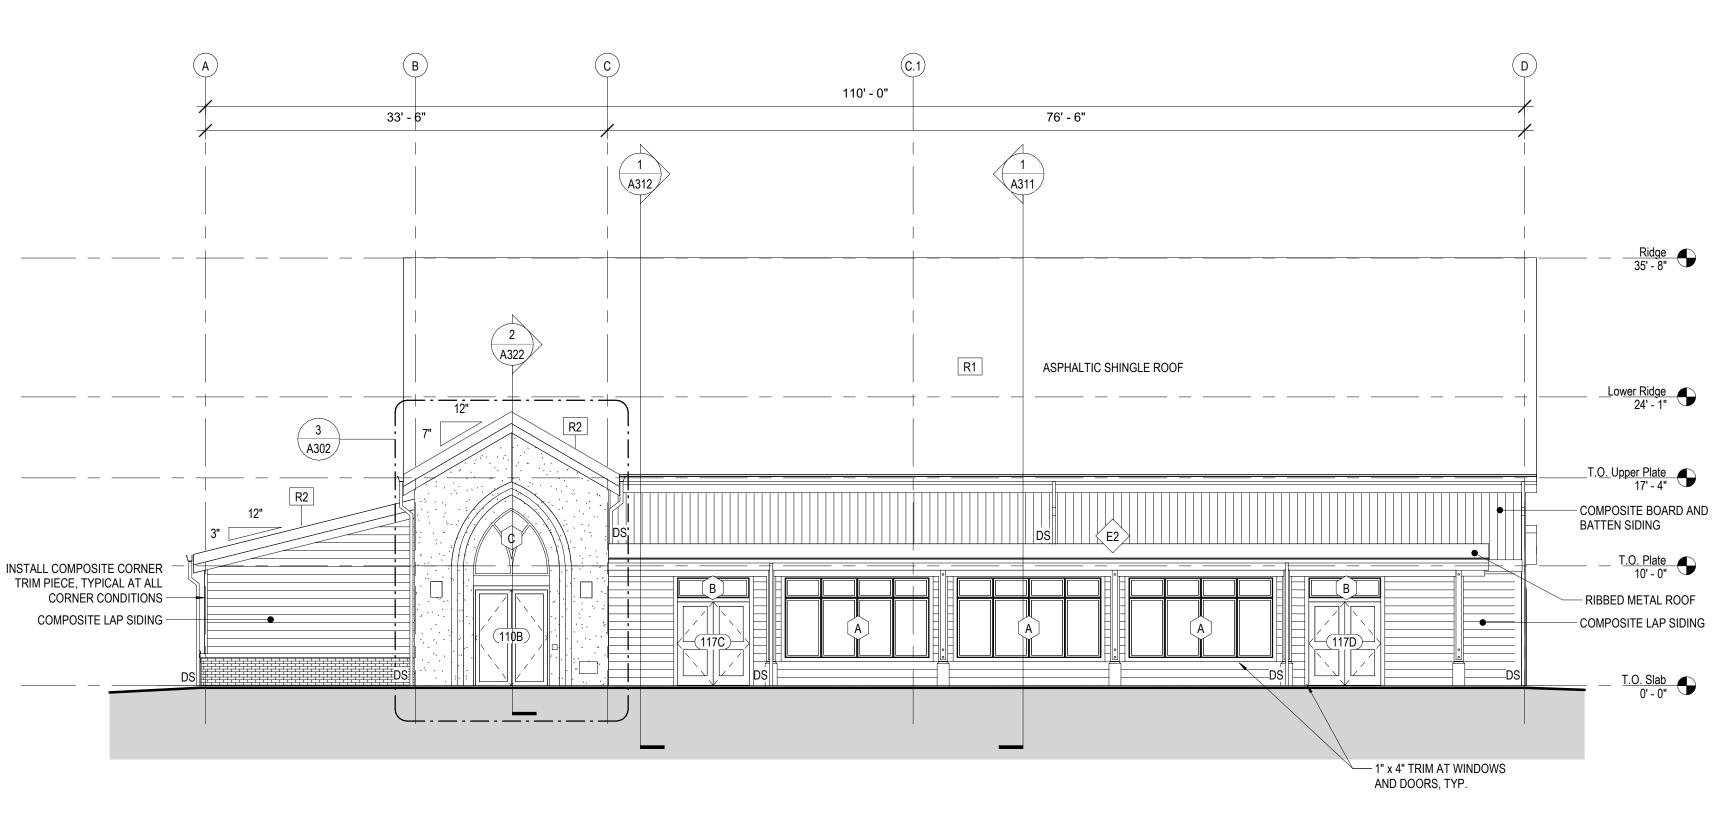

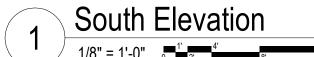Enlarged Decorative Gable Cross

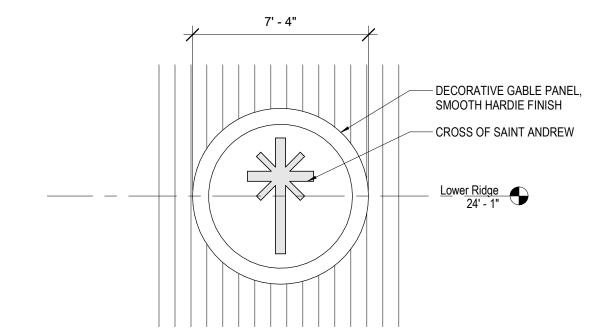1/4" = 1'-0"

1/4" = 1'-0"

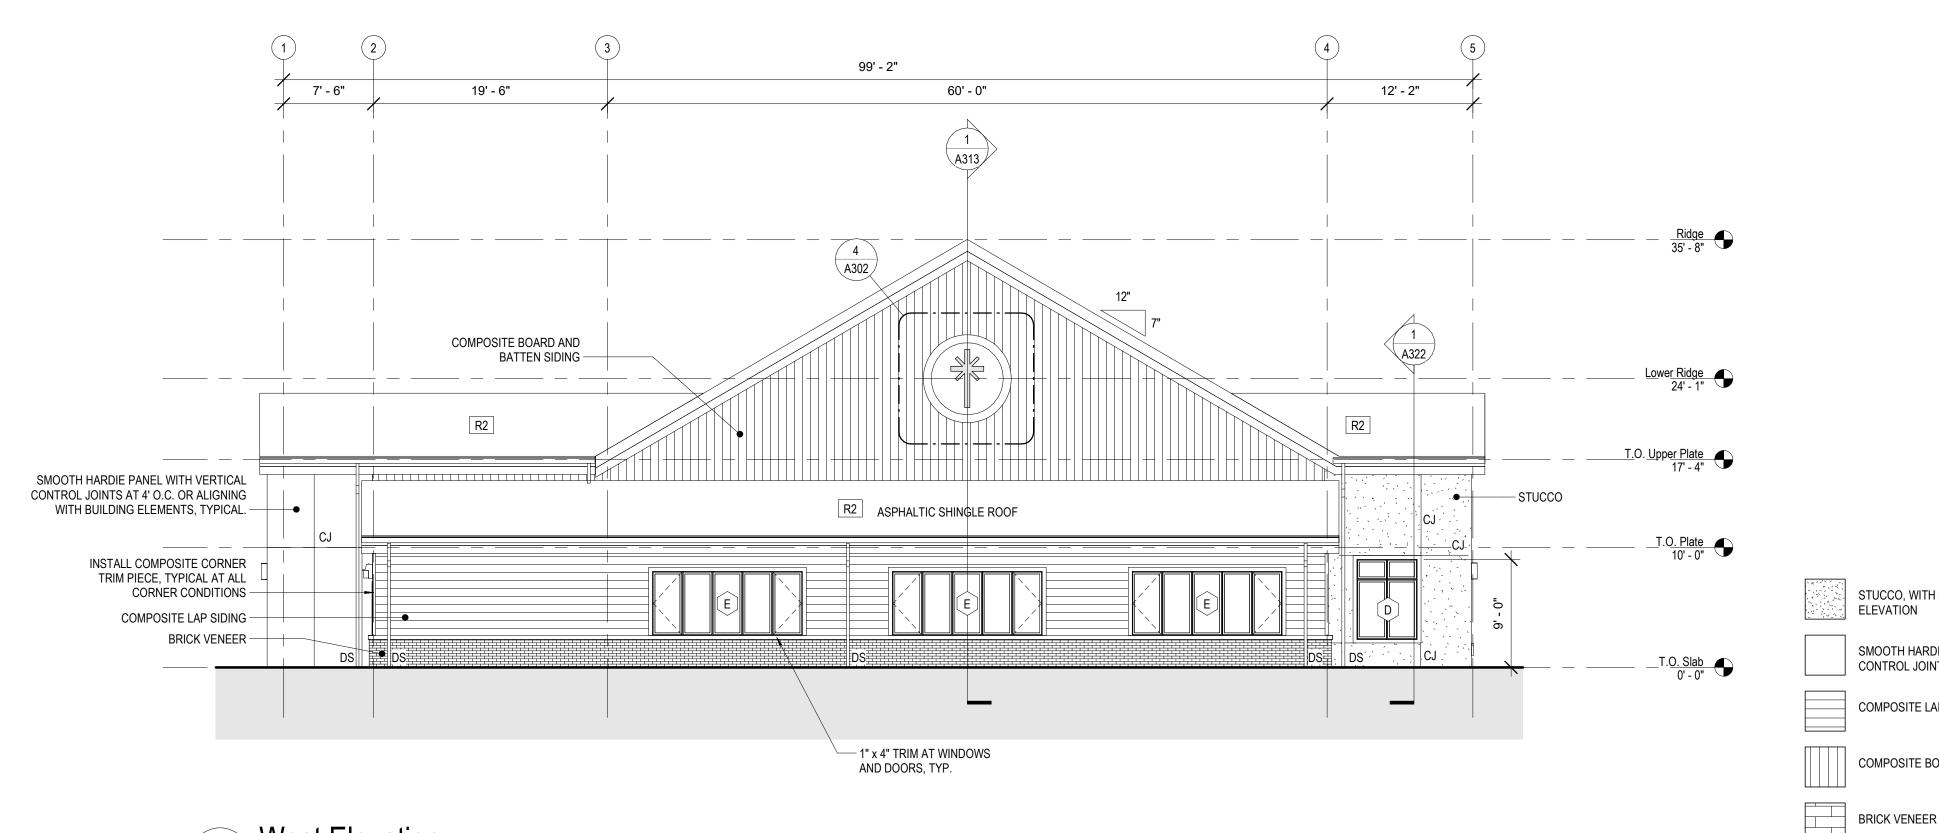

West Elevation

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STUCCO, WITH CONTROL JOINTS PER

SMOOTH HARDIE PANELING WITH CONTROL JOINTS PER ELEVATION

COMPOSITE BOARD AND BATTEN SIDING

COMPOSITE LAP SIDING

ELEVATION

V

BRADLEY P. CORNWELL STATE OF WASHINGTO

diocese of Seattle

Andrew Catholic Church
Valley Avenue East

Job No: 1851 Date: 2020-02-07
File No: 1851 St. Andrew Parish Hall
Drawn By: AMR
Checked By: BPC
Issued for: PERMIT SET
BUILDING

**ELEVATIONS** 


Archdiocese of Seattle

St. Andrew Catholic Church Parish Hall
1401 Valley Avenue East
Sumner, WA 98390-2720

Job No: 1851 Date: 2020-02-07
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BUILDING SECTIONS



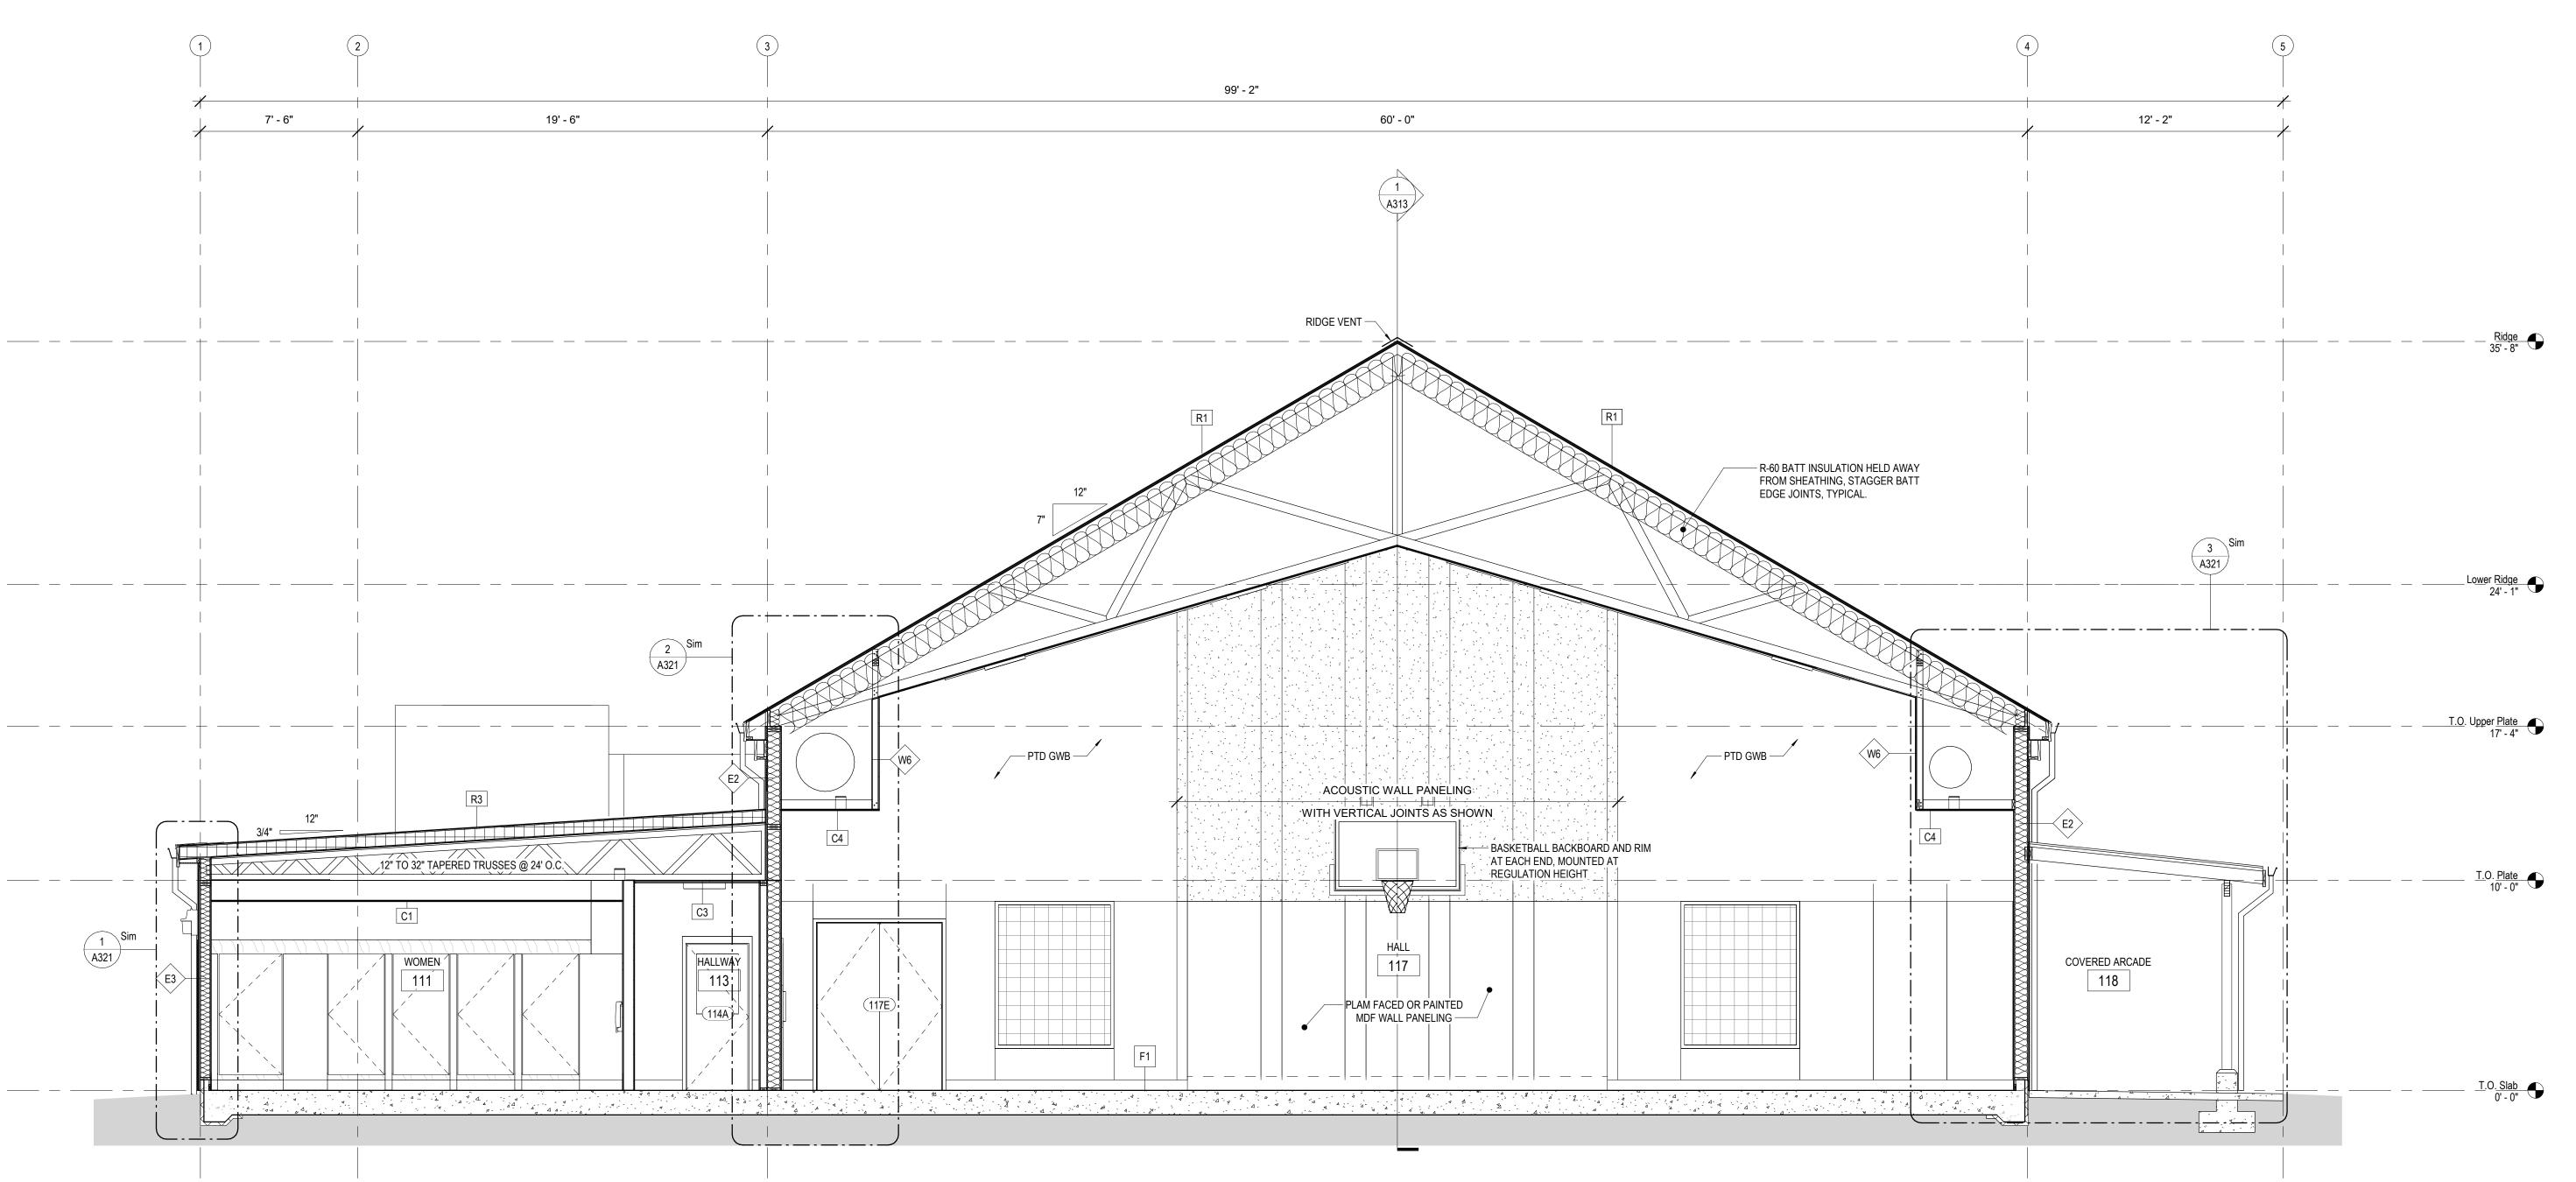

1 N-S Section 2


1/4" = 1'-0" 0 1'-2' 4'

Archdiocese of Seattle

St. Andrew Catholic Church Parish
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Sumner, WA 98390-2720

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BUILDING SECTIONS

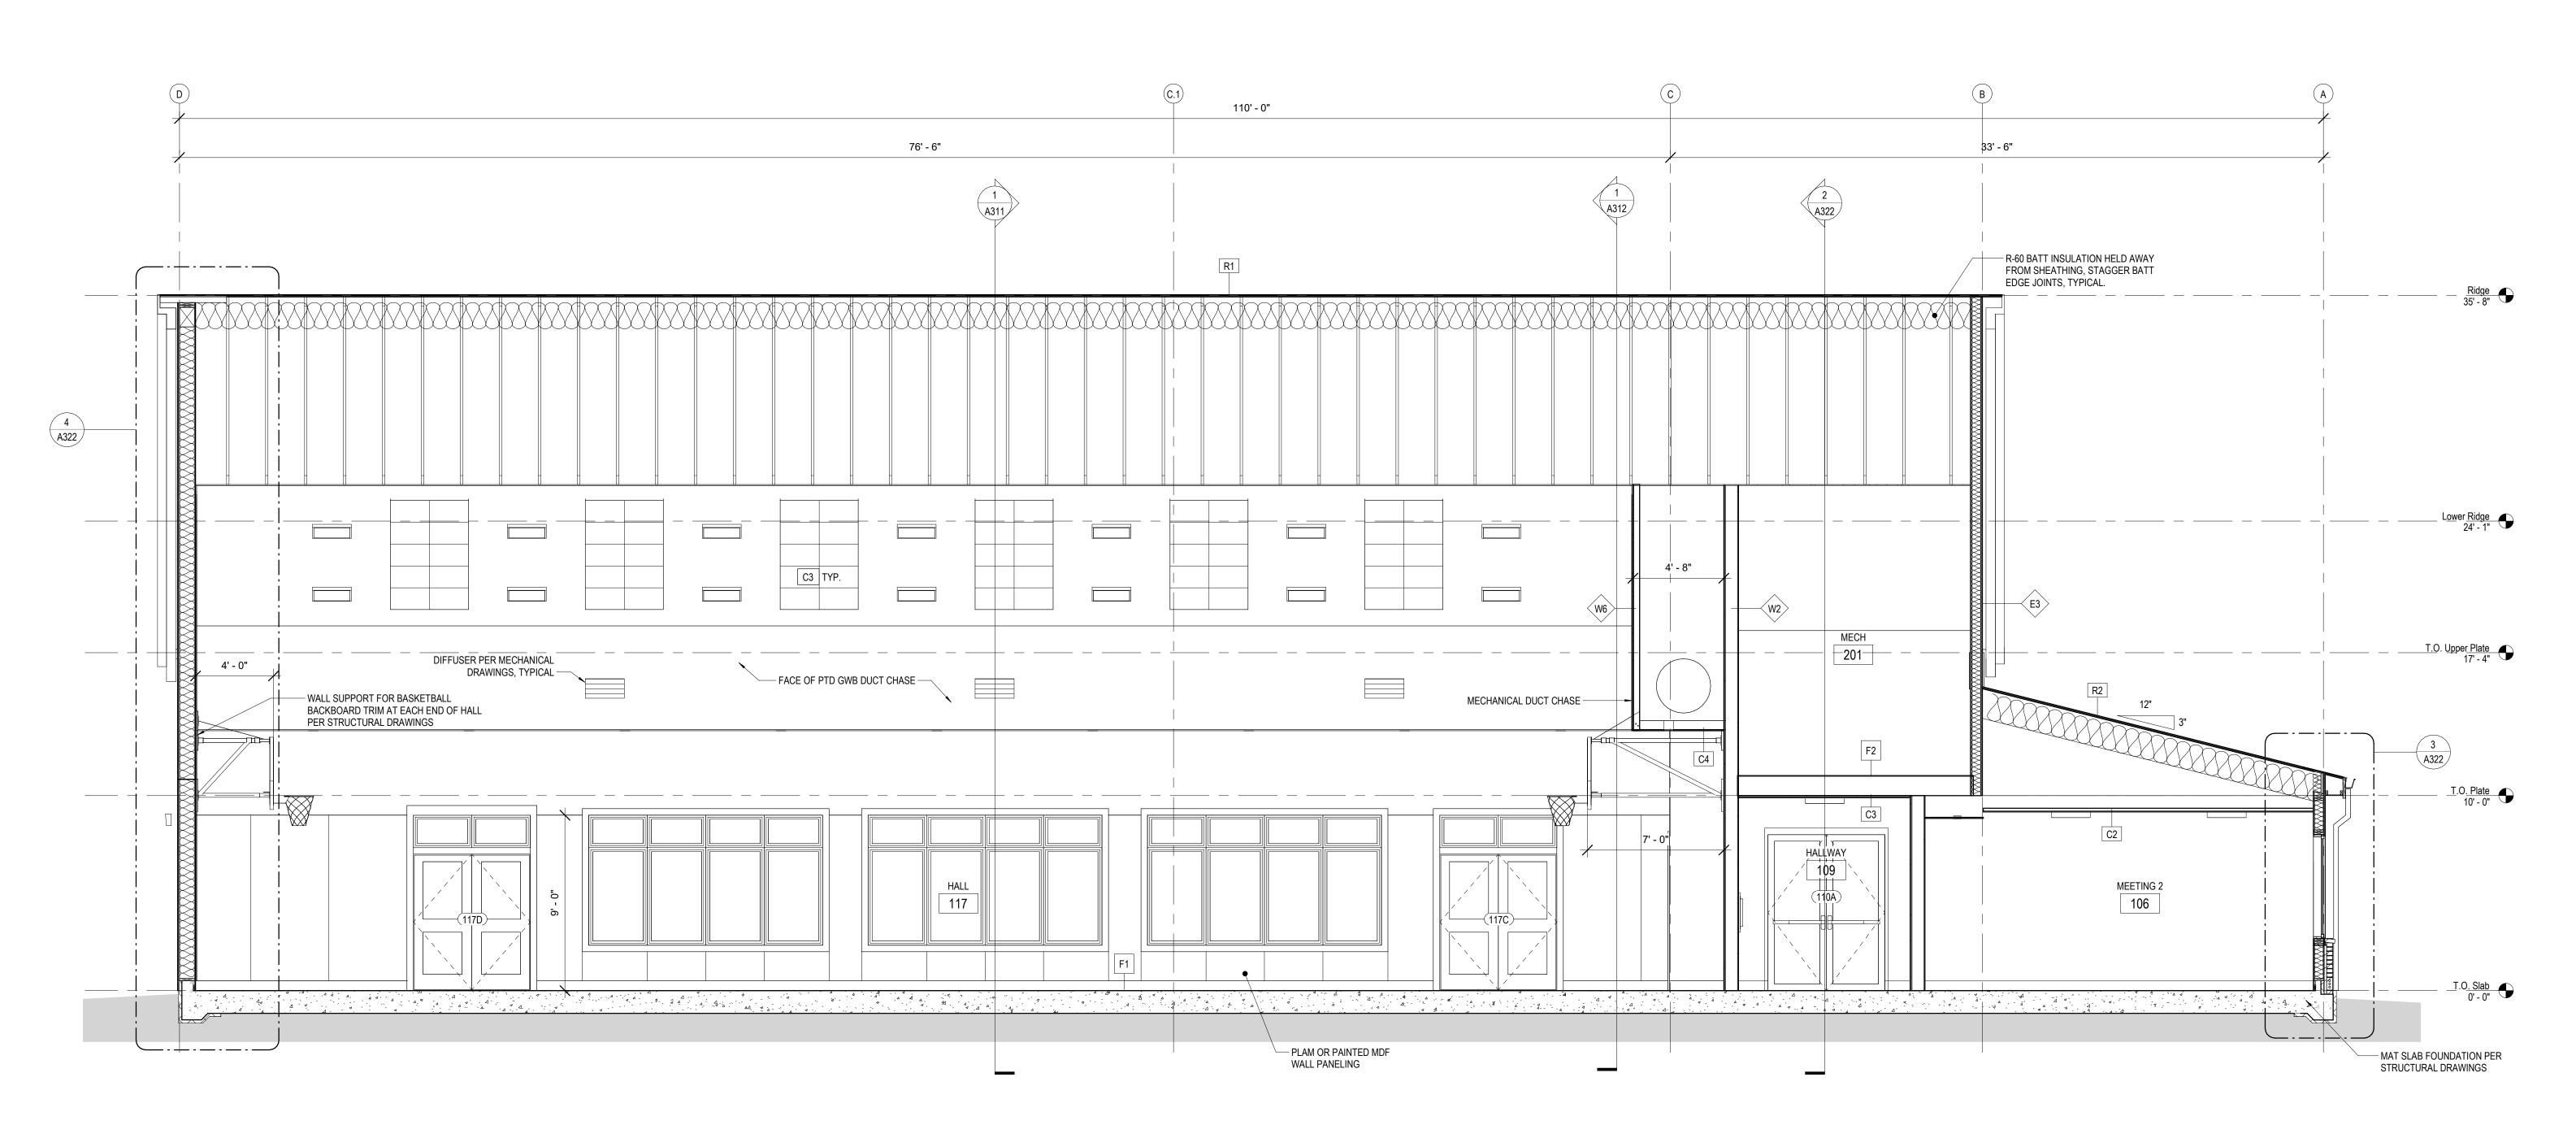

Archdiocese of Seattle

St. Andrew Catholic Church Parish Hall
1401 Valley Avenue East
Sumner, WA 98390-2720

Archdioces

Job No: 1851 Date: 2020-02-07

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Augustian St. Augus

SECTIONS

BUILDING

1 E-W Section 1

1/4" = 1'-0" 0 1 2

Andrew Catholic Church F Valley Avenue East her, WA 98390-2720

T<u>.O</u>. P<u>late</u> 10' - 0"

\_\_\_\_\_C2

—<u>E3</u>

Wall Section at Membrane Roof

1/2" = 1'-0"

The section at Membrane Roof

— SLOPE GRADE, MIN. 2% AWAY FROM BUILDING


 
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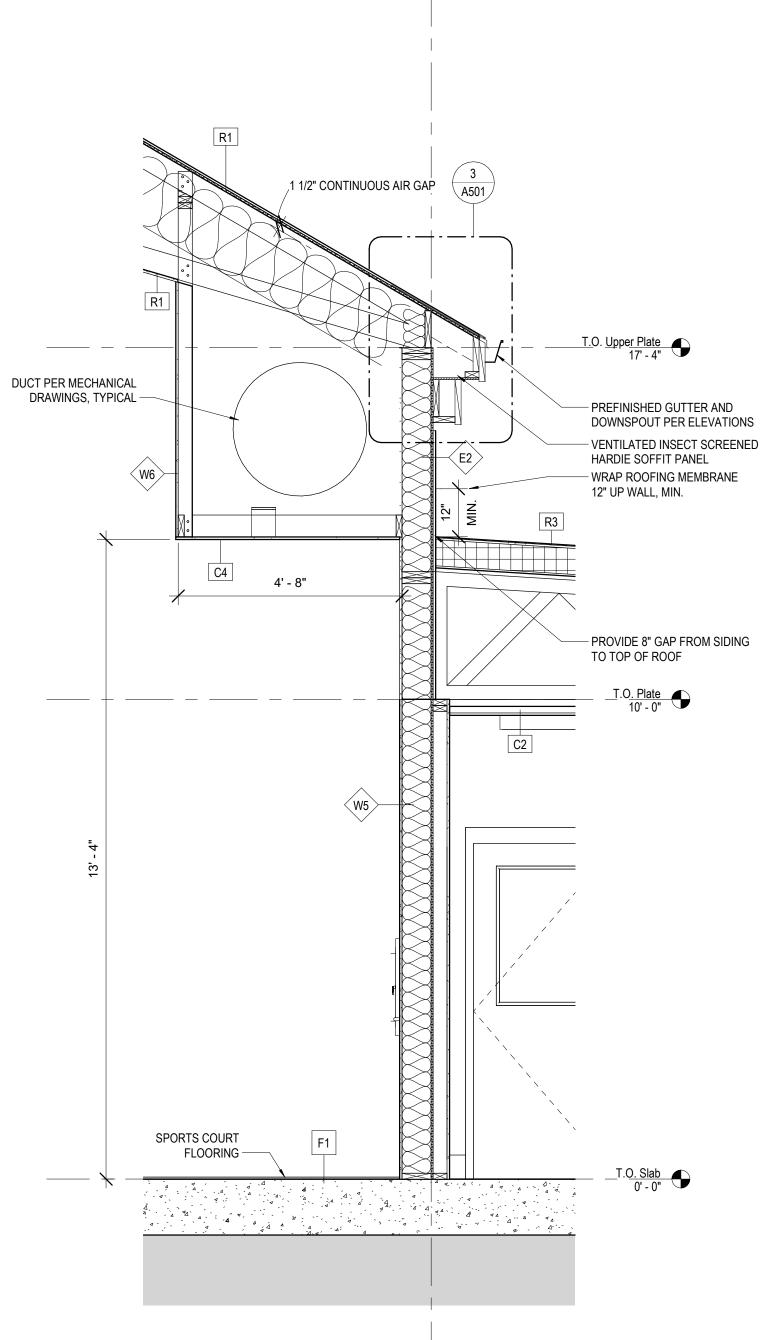
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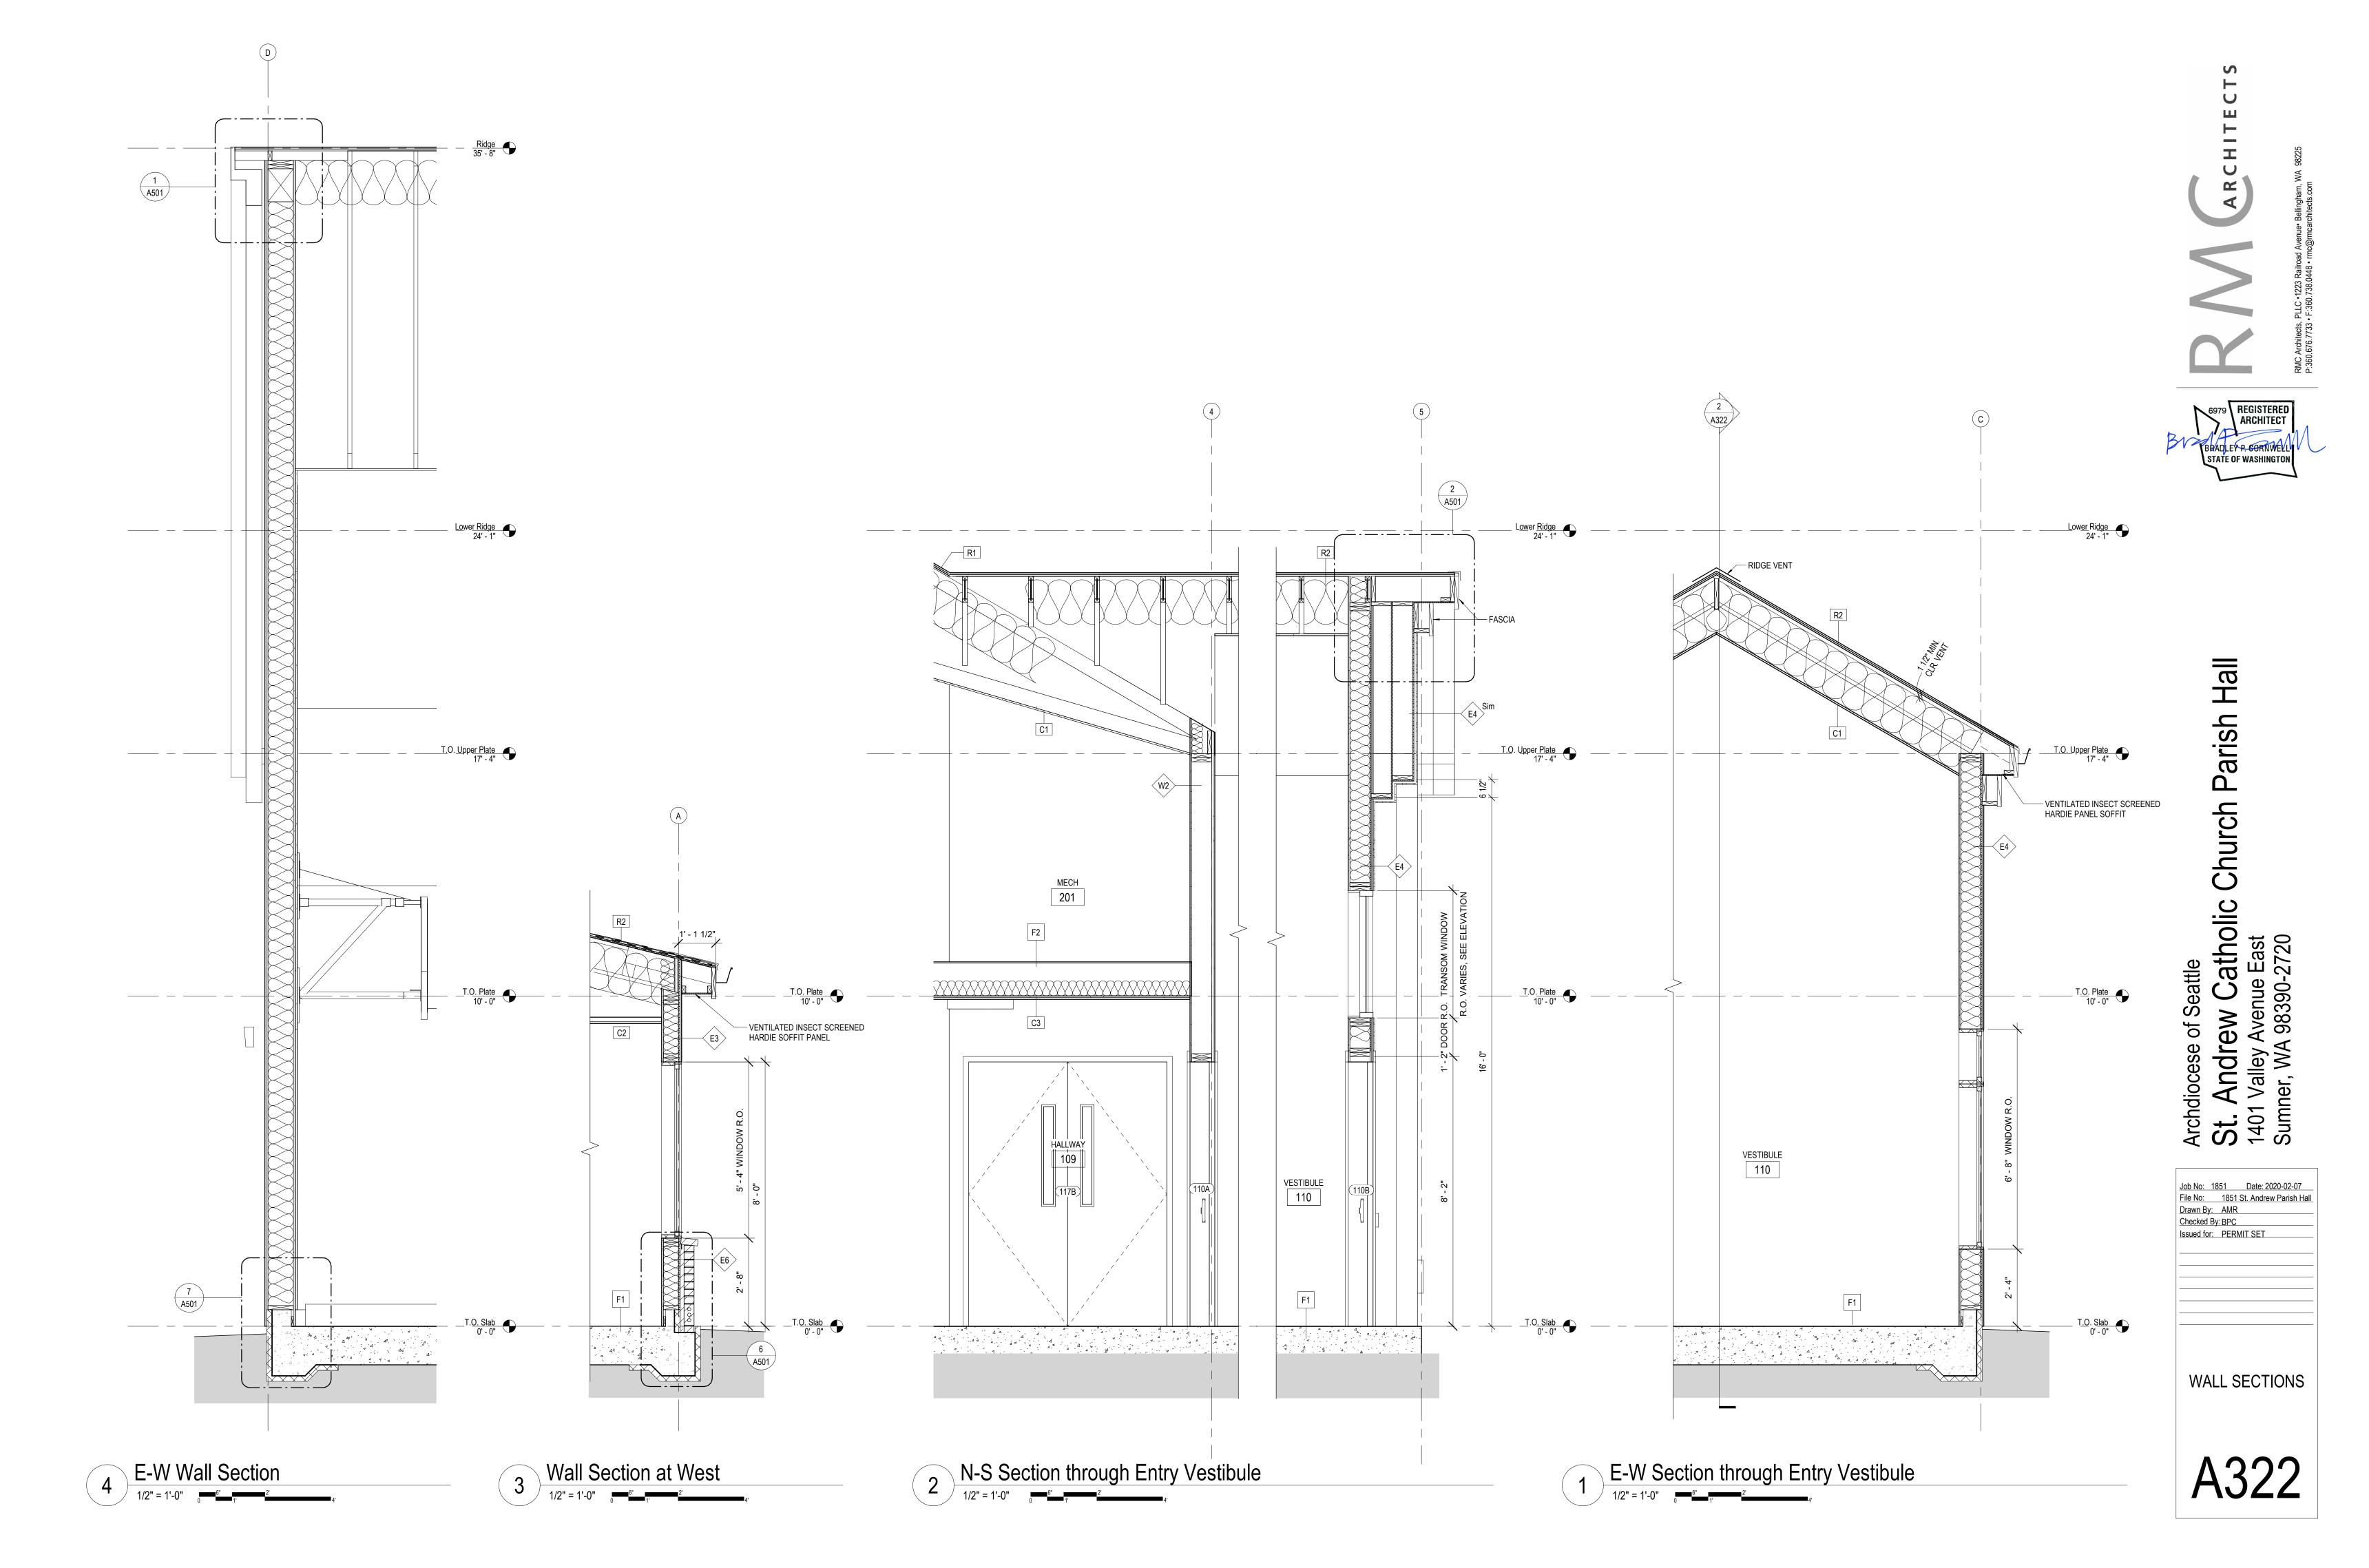
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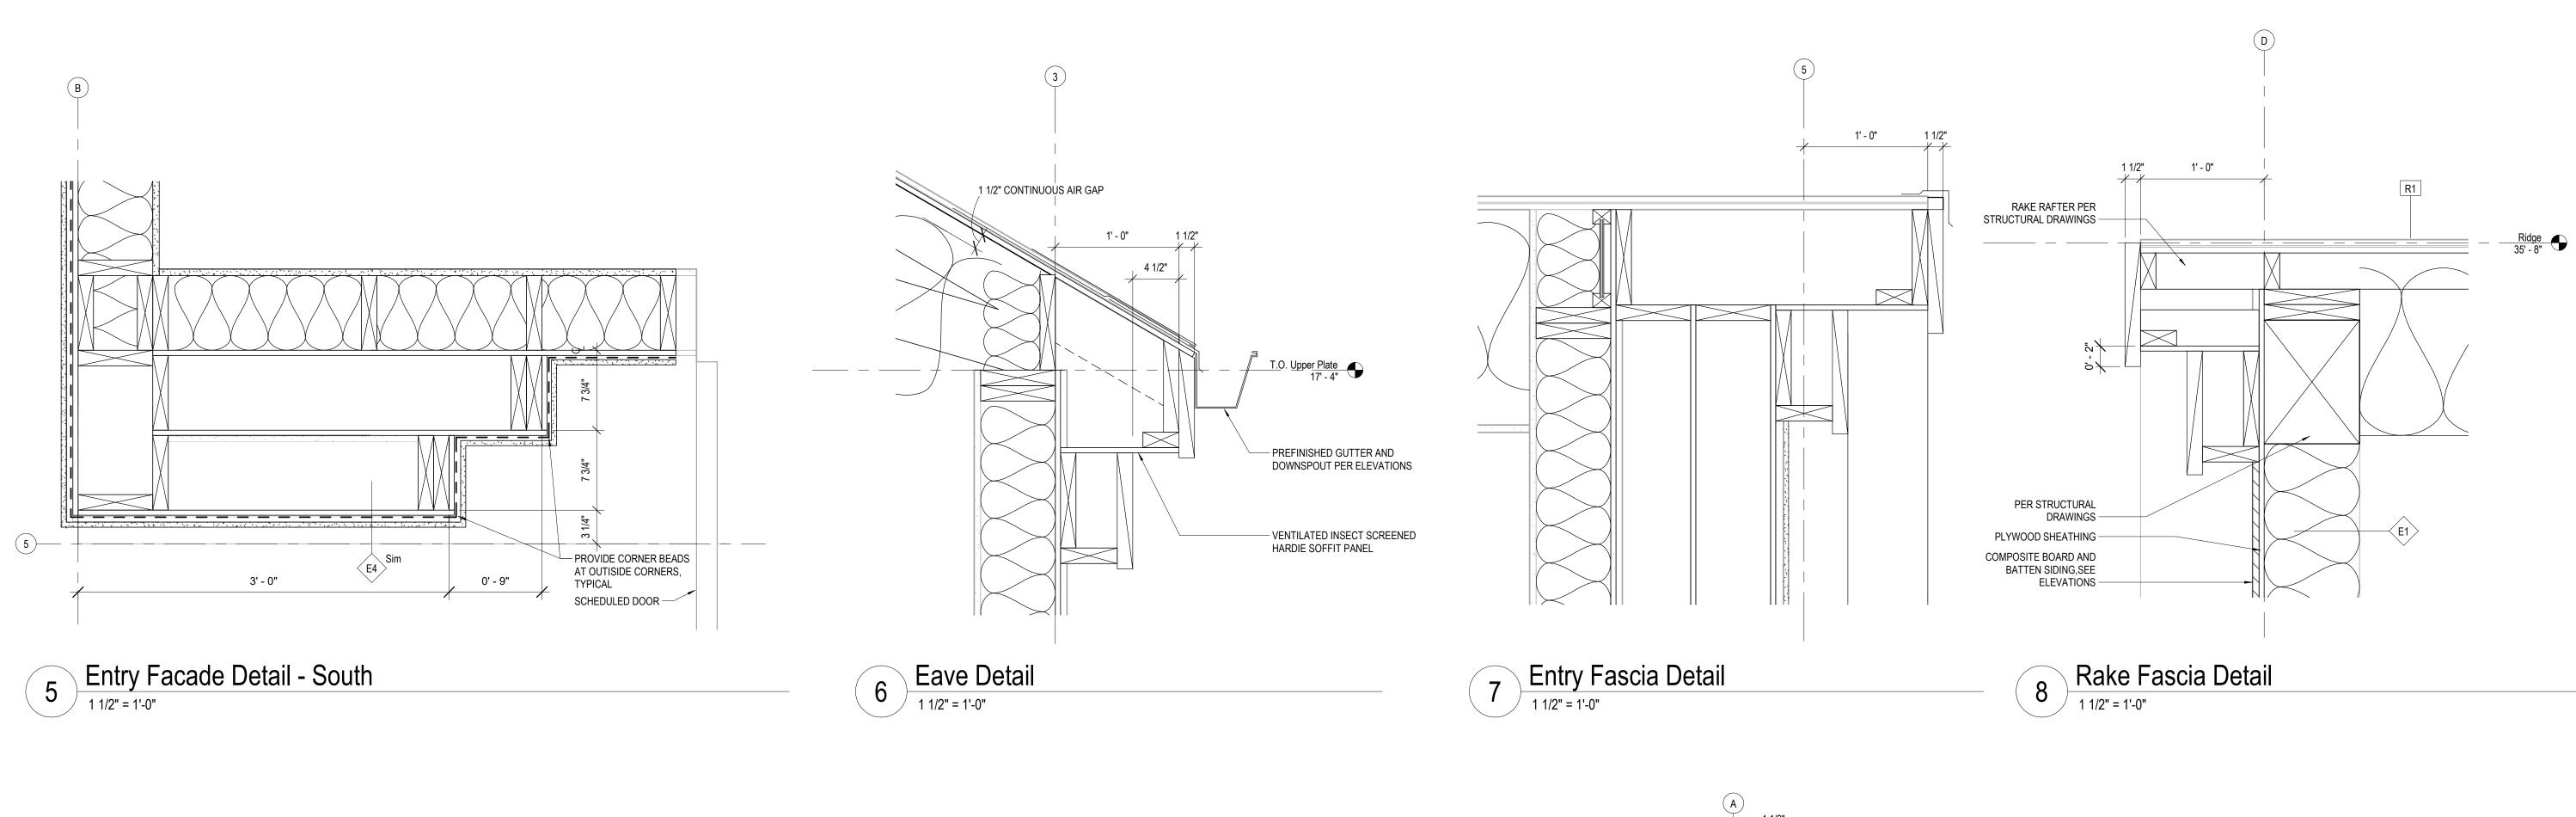
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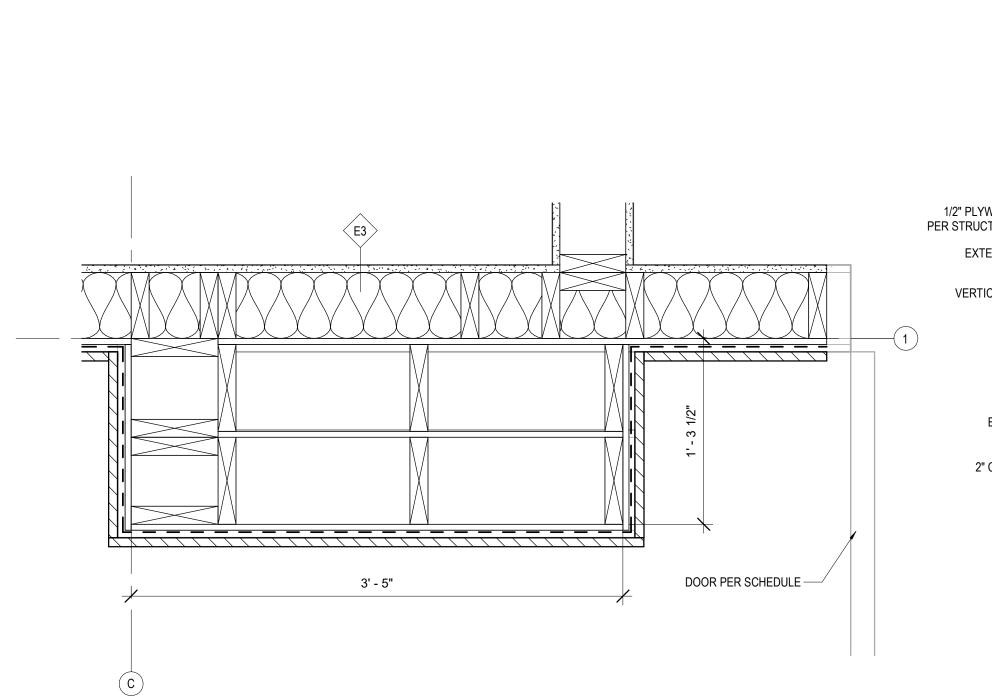
WALL SECTIONS











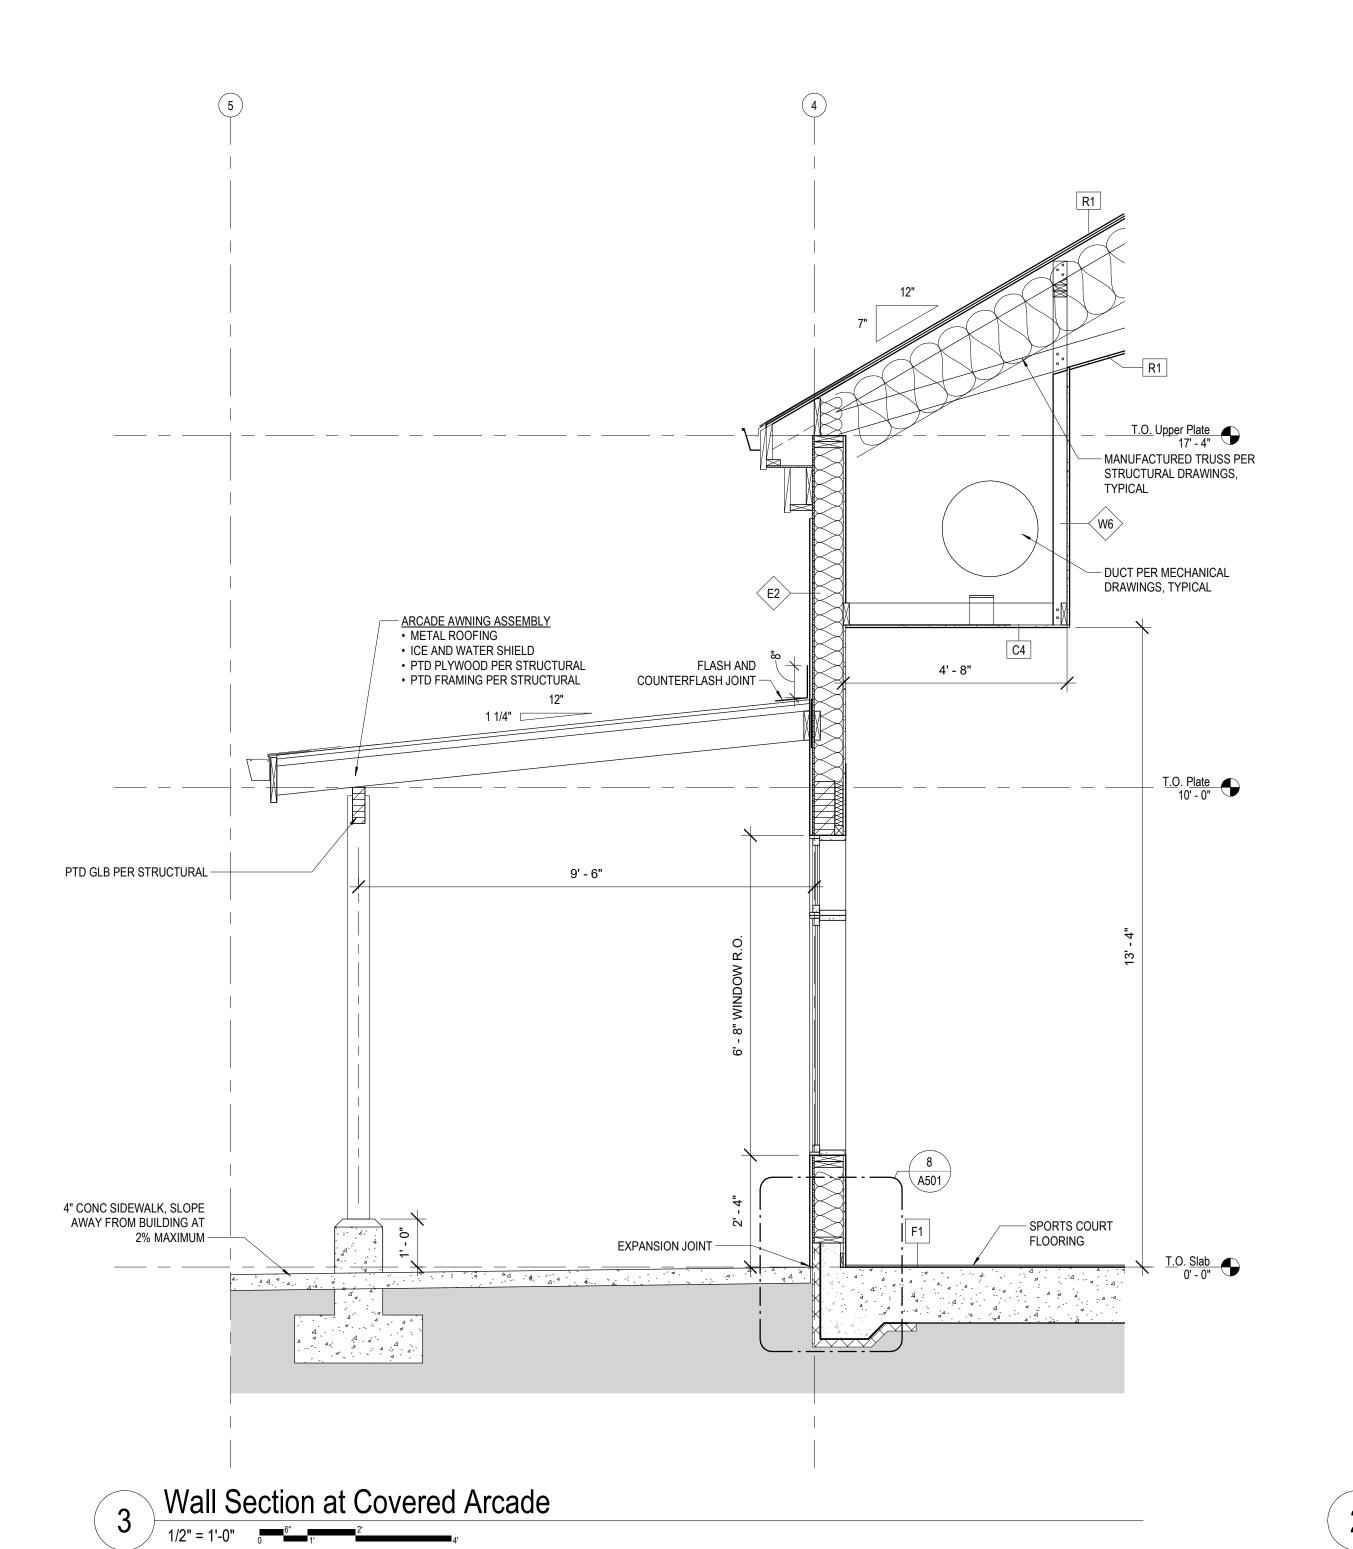



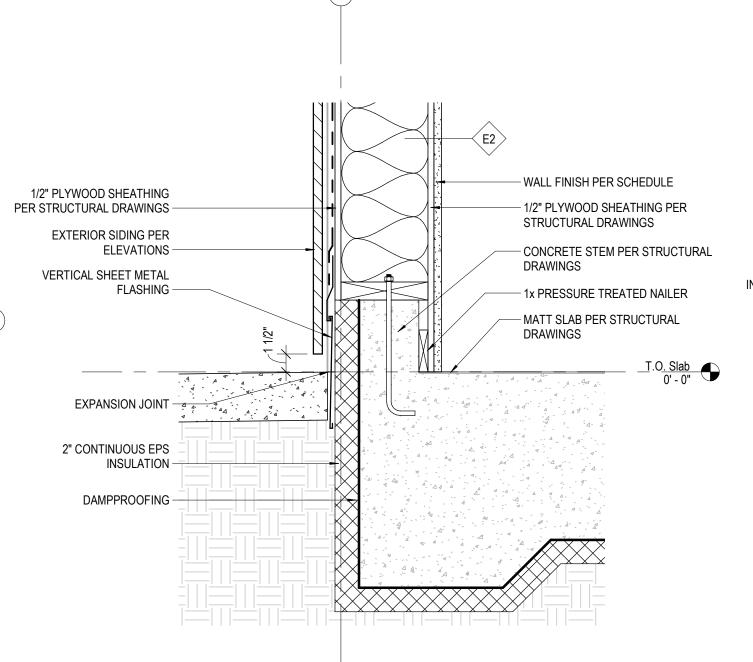



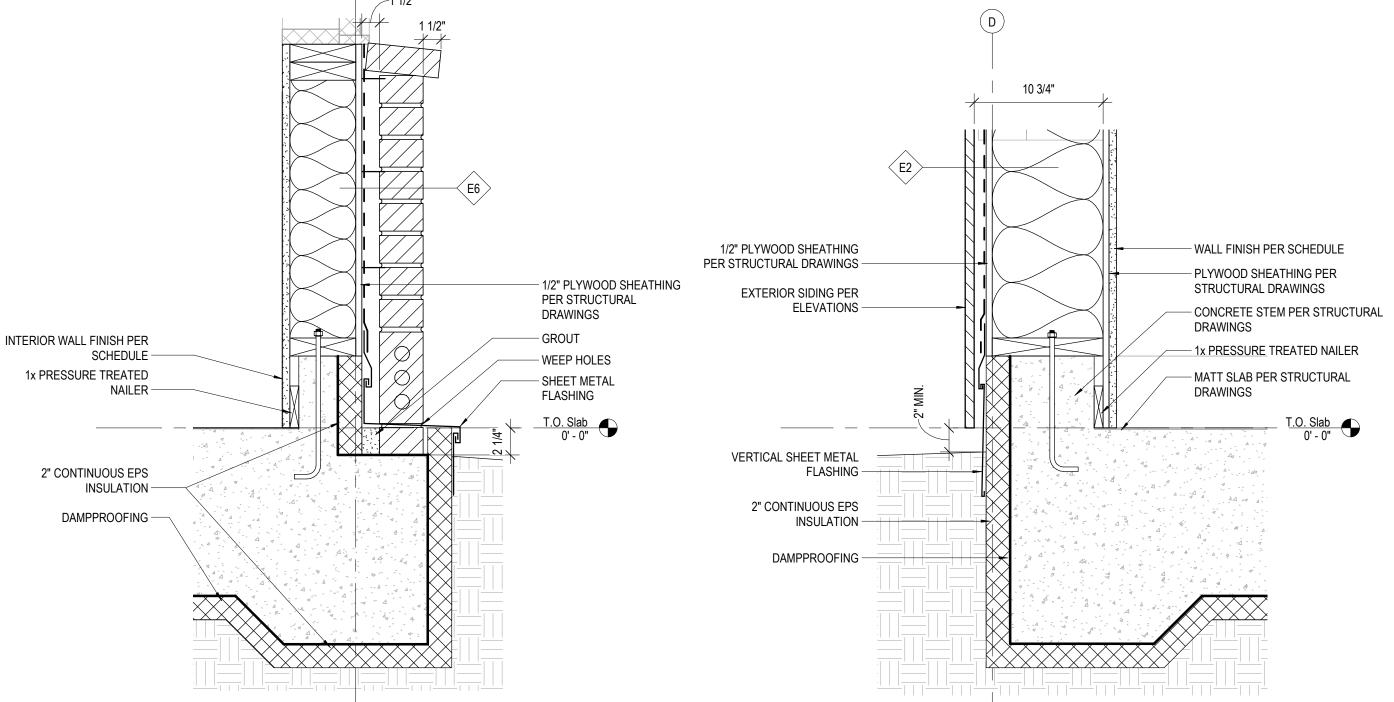


Foundation at Brick Veneer

1 1/2" = 1'-0"

Foundation Detail

1 1/2" = 1'-0" 0 2" 4" 1'-4" 1'-4" 2'

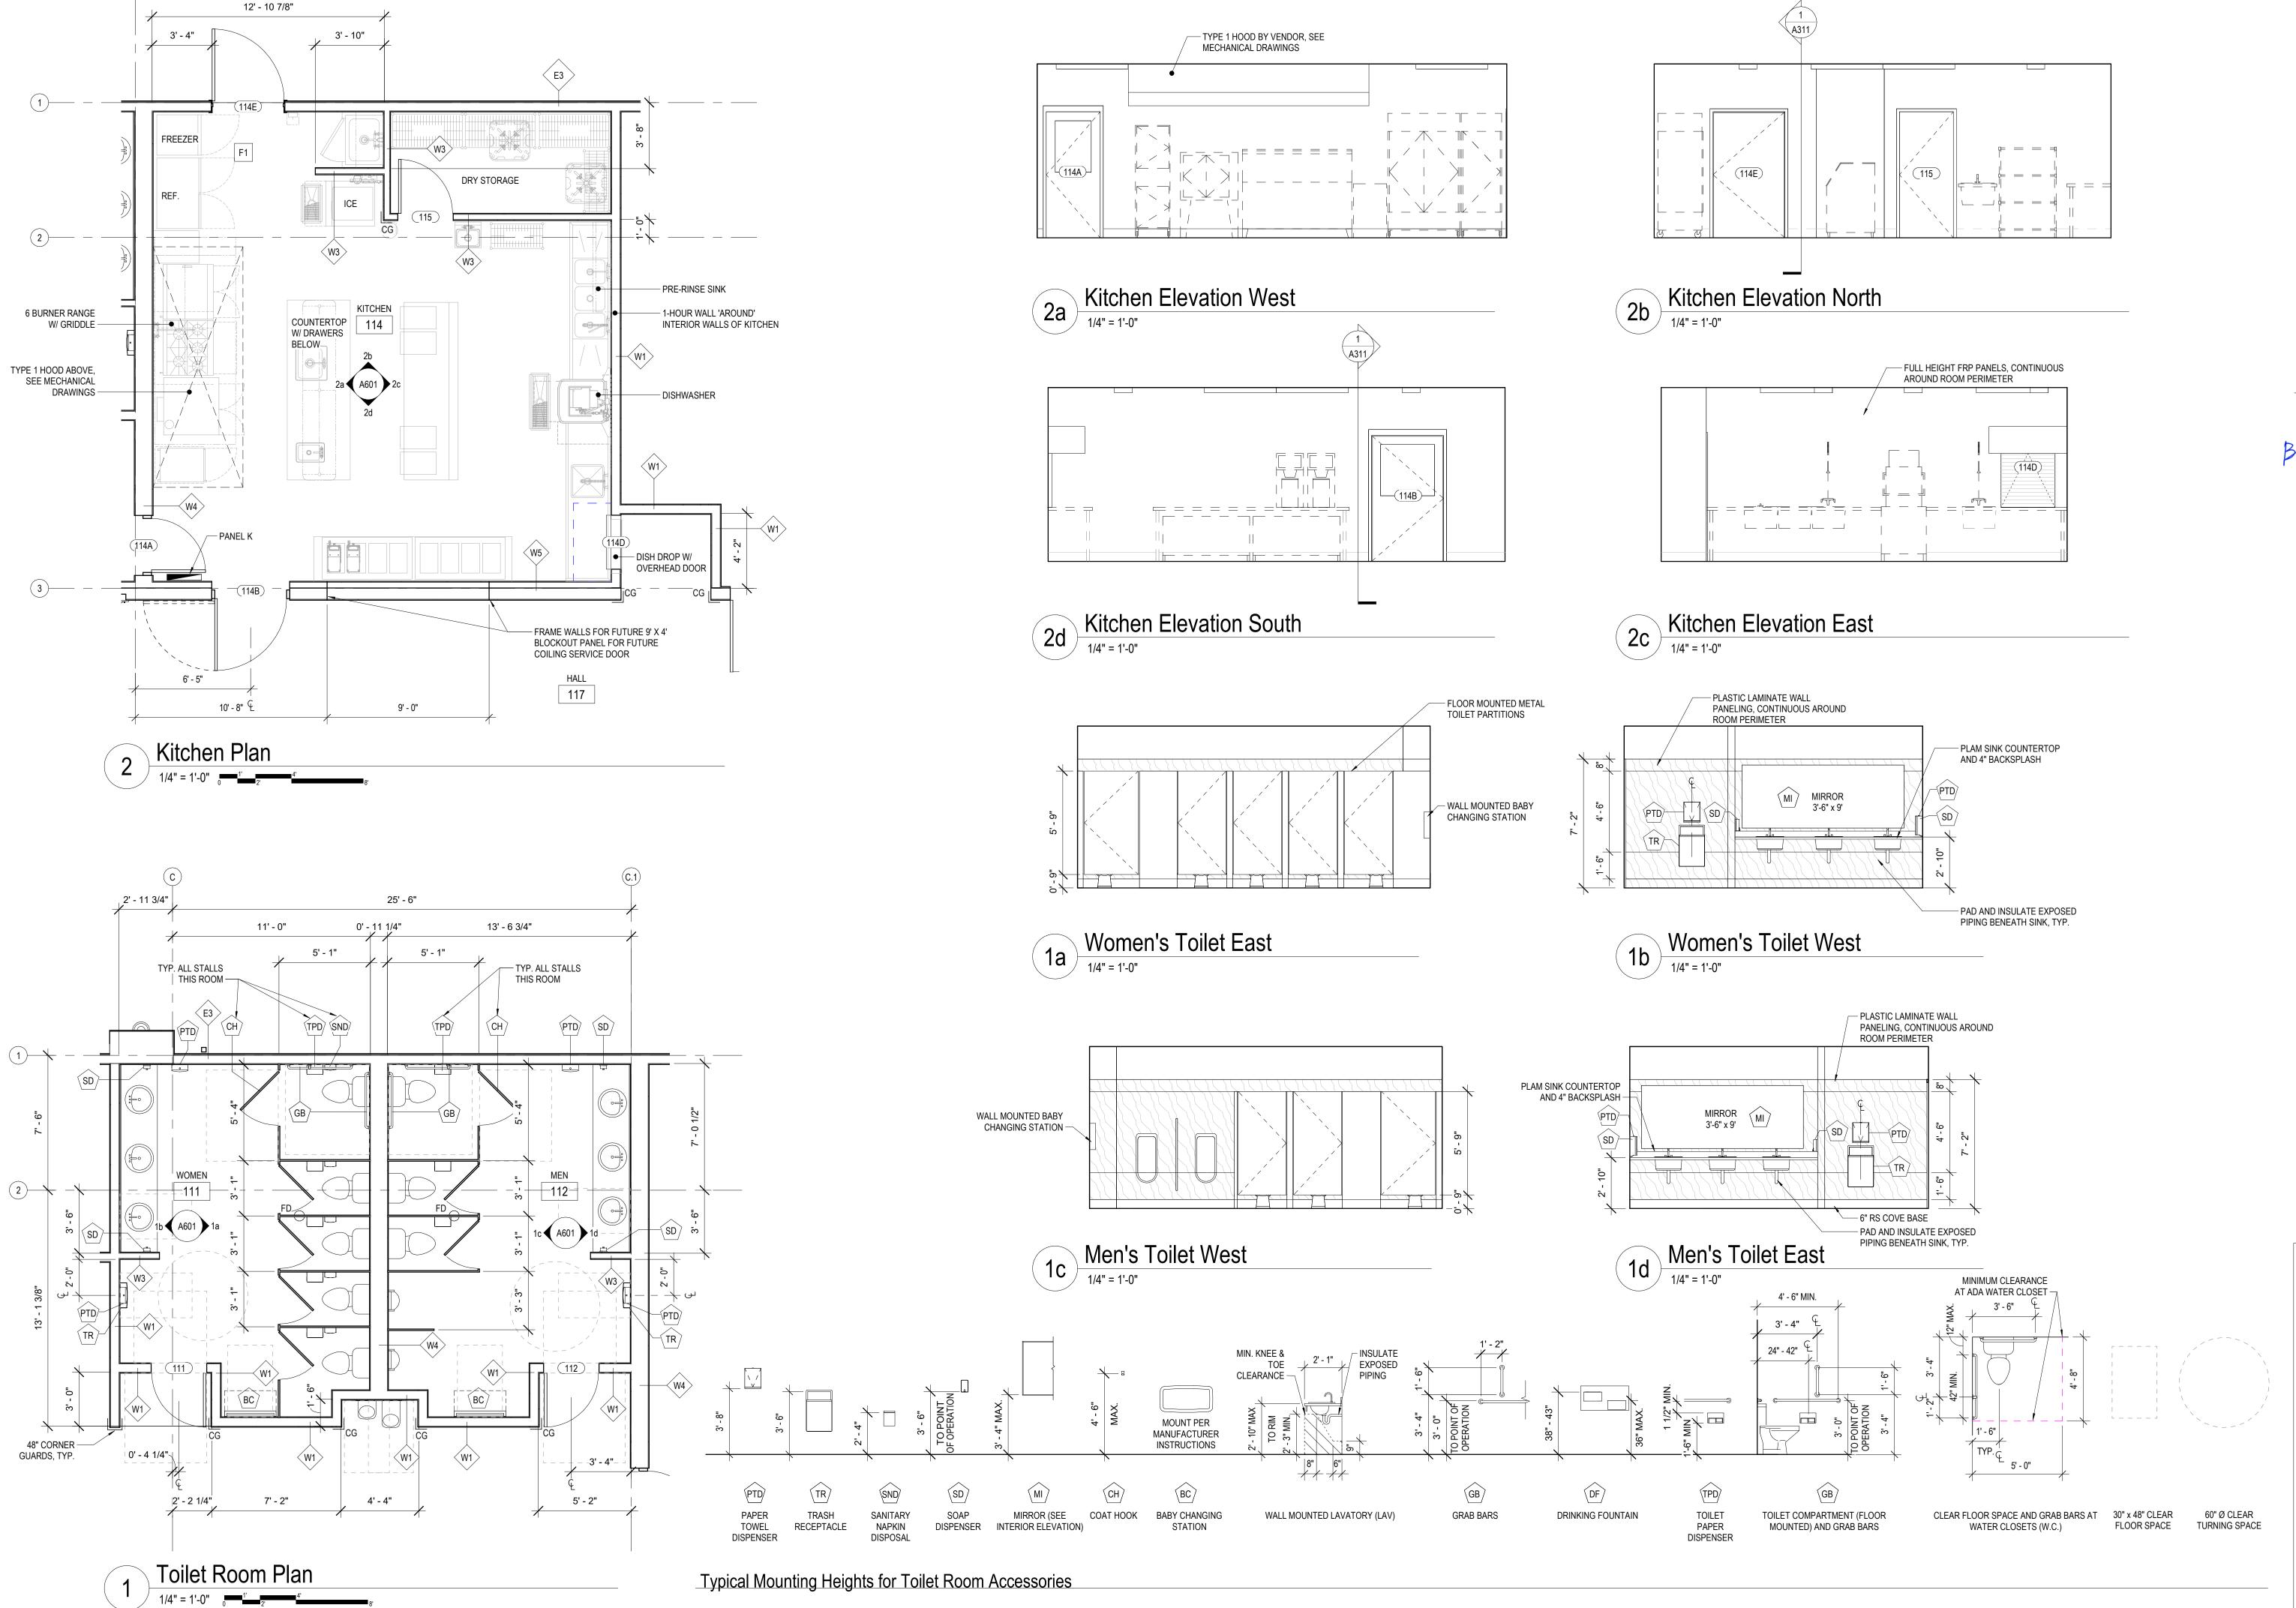

ARCHITECT

BRADLEY P. GORNWELL STATE OF WASHINGTON

Archdiocese of Seattle

St. Andrew Catholic Church Parish Hall
1401 Valley Avenue East
Sumner, WA 98390-2720


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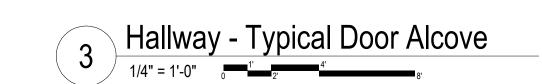
ENLARGED PLANS AND INTERIOR ELEVATIONS


A313 21' - 0" ACOUSTIC WALL PANELING SURFACE APPLIED ACT PANELS, SEE 1 / A210 DIFFUSER PER MECHANICAL DRAIWNGS, TYP. EDGE OF SOFFIT DUCT CHASE PTD GWB — PTD GWB — — BASKETBALL BACKBOARD AND RIM MOUNTED AT REGULATION PTD GWB — HEIGHT 117 PLAM FACED OR PAINTED MDF WALL PANELING 6" 3' - 6" 1' - 0" 3' - 0" 1' - 0" 3' - 0" 1' - 0" 3' - 0" 1' - 0" 3' - 6" 6" JOINT SPACING WALL SHOWN AT OBLIQUE ANGLE TO VIEW WALL SHOWN AT OBLIQUE ANGLE TO VIEW NOTE: ALL VERTICAL JOINTS ARE 4'-0" O.C., UNLESS NOTED OTHERWISE, OR ALIGNED TO BUILDING ELEMENTS AS SHOWN ON INTERIOR ELEVATIONS, TYPICAL.

1 A313 ACOUSTIC WALL PANELING — SURFACE APPLIED ACT TILES, SEE 1 / A210 PTD GWB — BASKETBALL BACKBOARD AND RIM MOUNTED AT REGULATION HEIGHT 117 PLAM FACED OR PAINTED MDF WALL PANELING 8" PORTABLE EVENT PLATFORM BY PARISH 3'-6" 1'-0" 3'-0" 1'-0" 3'-0" 1'-0" 3'-6" 6"

JOINT SPACING NOTE: ALL VERTICAL JOINTS ARE 4'-0" O.C., UNLESS NOTED OTHERWISE, OR ALIGNED TO BUILDING ELEMENTS AS SHOWN ON INTERIOR ELEVATIONS, TYPICAL.



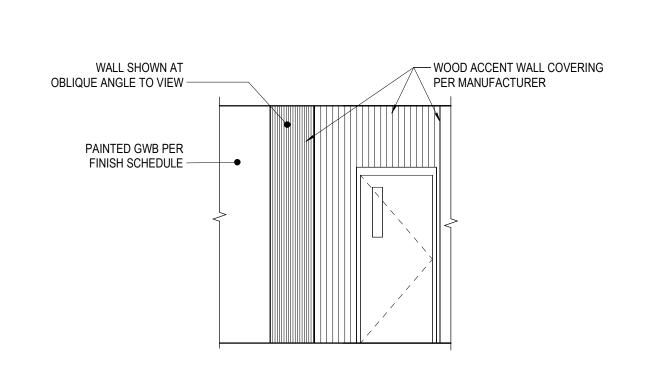


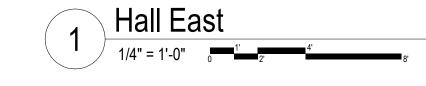


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> INTERIOR **ELEVATIONS**



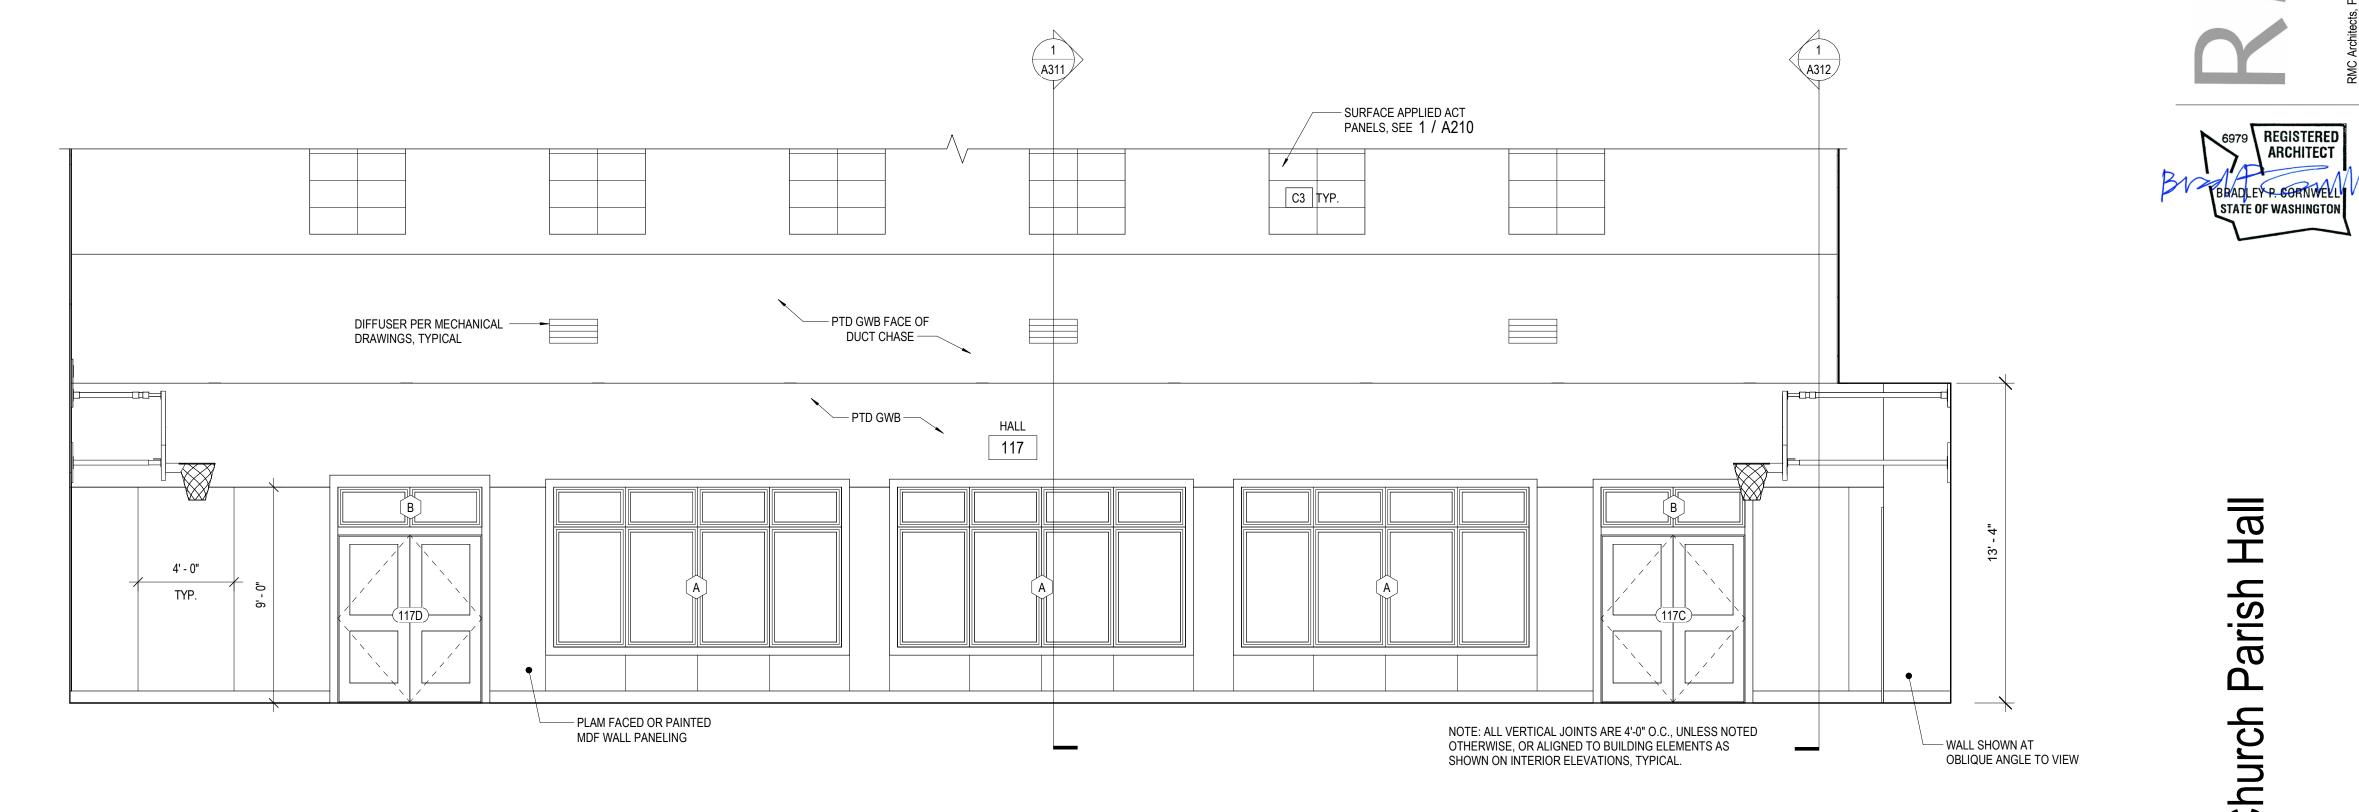

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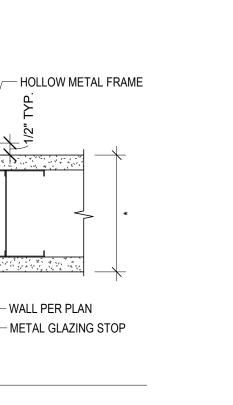
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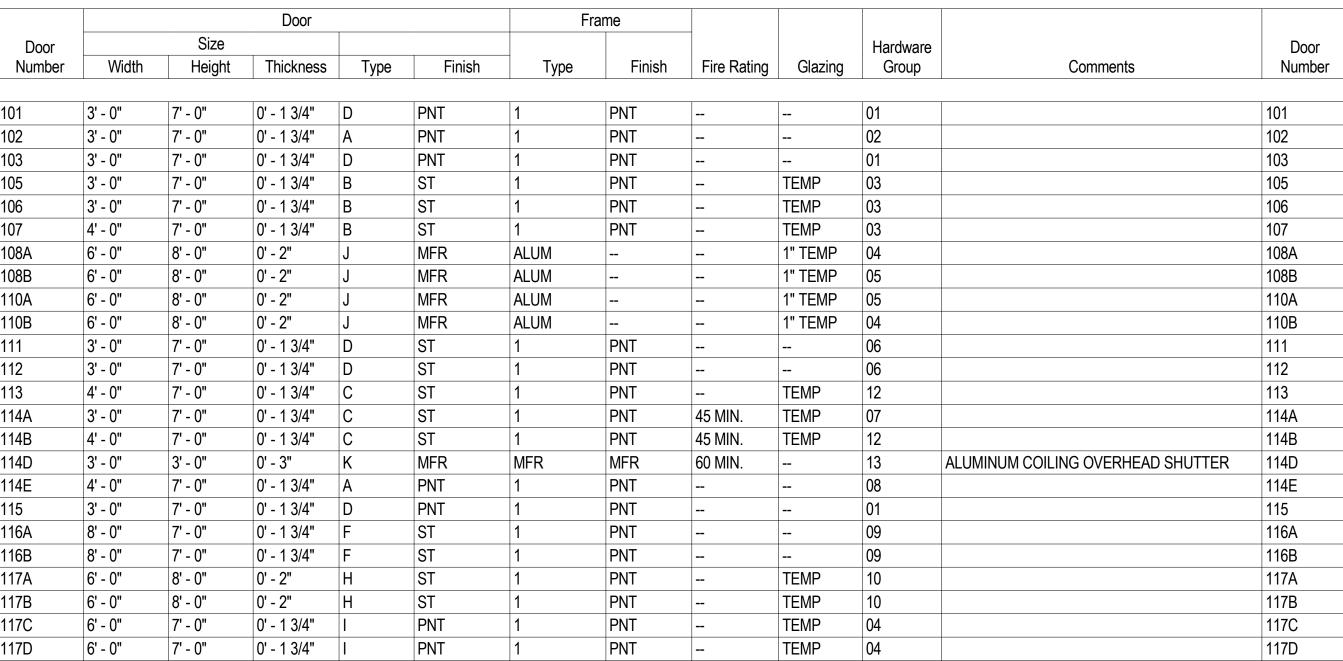
 
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Door Schedule

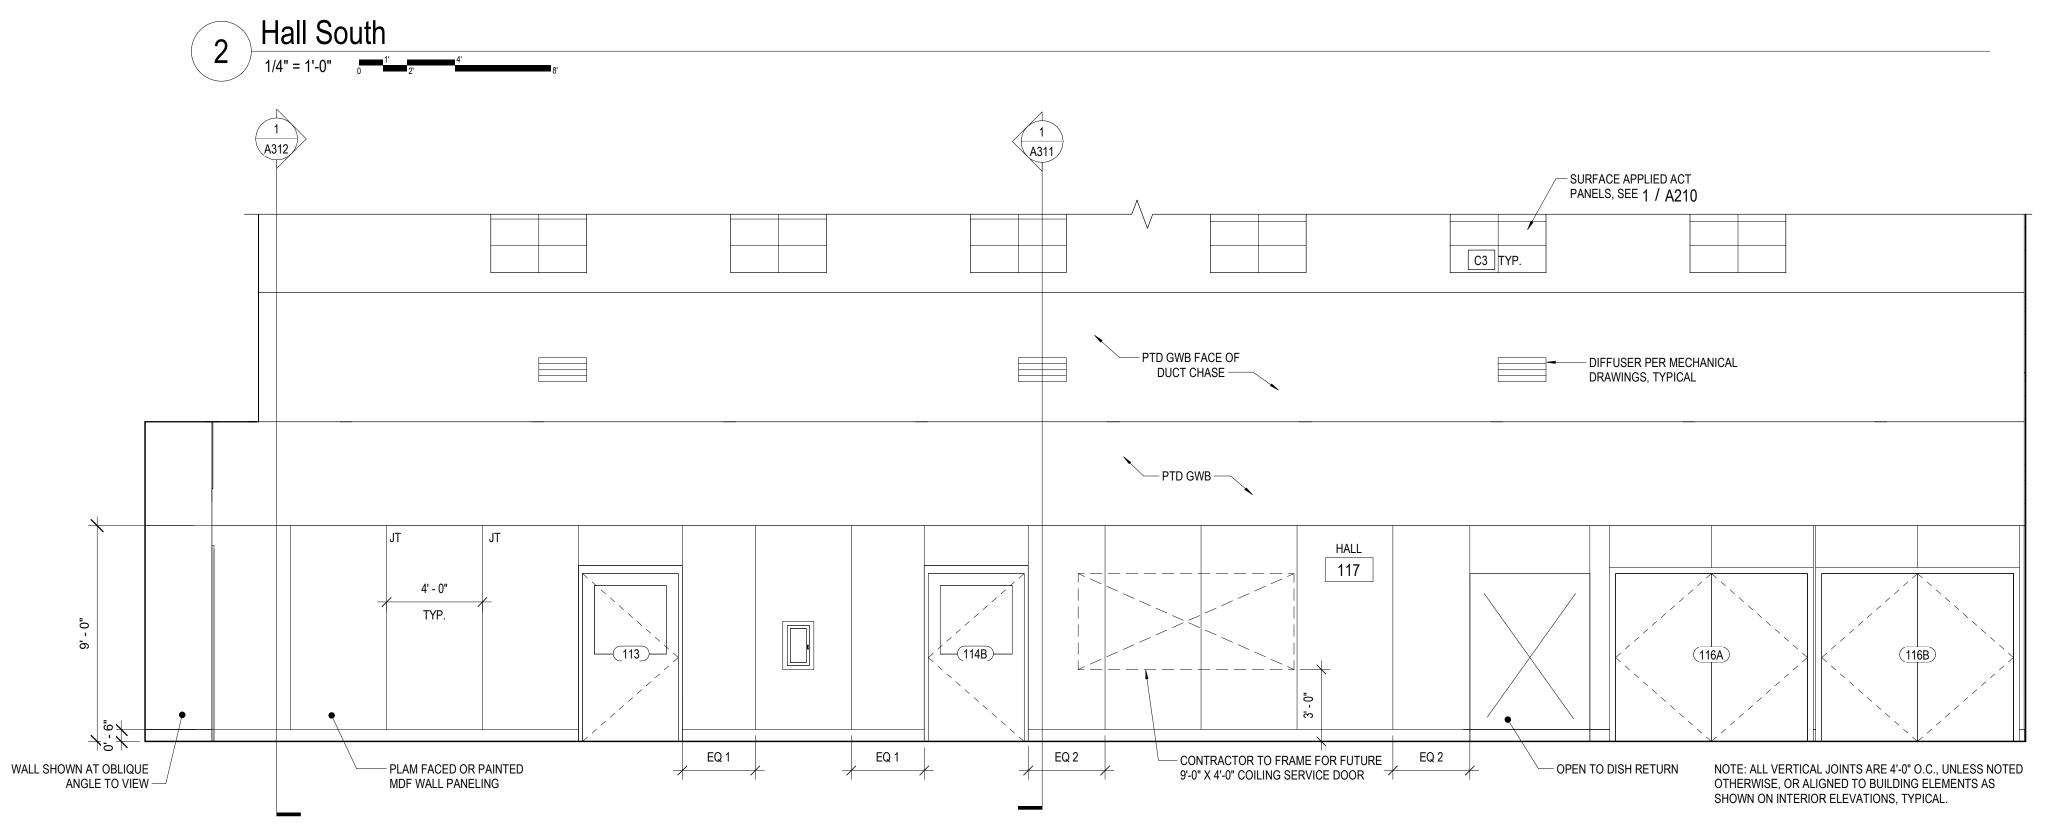108A 114A 114D

0' - 1 3/4"

PNT

CAULK PERIMERTER OF FRAME WITH ACOUSTIC -SEE FRAME TYPE FOR DIMENSION SEALANT HOLLOW METAL DOOR FRAME — DOOR LEAF WALL PER PLAN

SEE FRAME TYPE FOR DIMENSION-

SEE FRAME TYPE FOR DIMENSION

SPECIFIED


HOLLOW METAL DOOR FRAME


Hollow Metal Relight (& Door)


3" = 1'-0"

Hollow Metal Door Jamb (Head Sim)

3" = 1'-0"

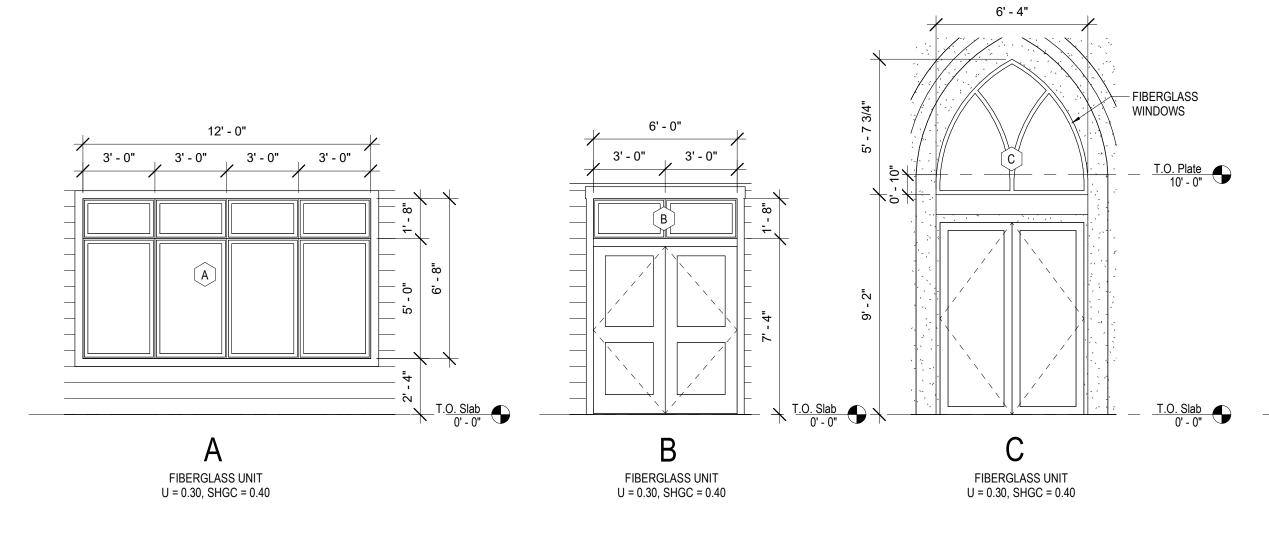

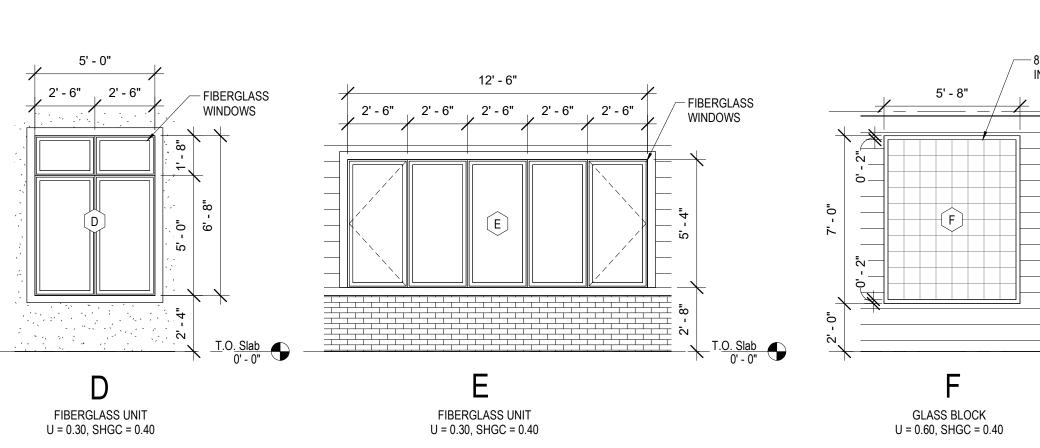

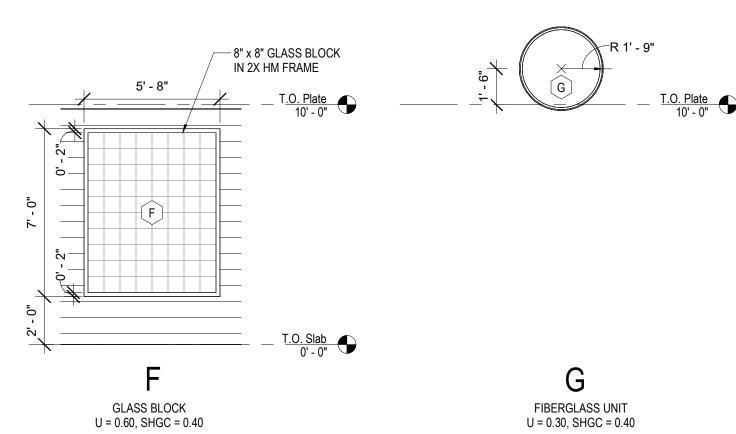

117E

Window Types

Door Frame Types

WINDOW TYPES GENERAL NOTES

1. SOME WINDOWS SHOWN ARE INTENDED FOR DIFFERING WALL ASSEMBLIES, COORDINATE INSTALLATION WITH

Door Types

2. SEE INTERIOR FINISH PLANS AND FINISH SCHEDULE FOR LOCATIONS OF INTERIOR WINDOW SHADES.

ASSEMBLIES AND DETAILS.

PER SCHEDULE PER SCHEDULE PER SCHEDULE PER SCHEDULE PER SCHEDULE PER SCHEDULE EQ. EQ. PER SCHEDULE PER SCHEDULE EQ. 0' - 5" 0' - 4" PER SCHEDULE VISION -PANEL PANEL SOLID CORE WOOD, VISION LITE FIRE RATED COILING OVERHEAD SHUTTER HOLLOW METAL, DOUBLE PANEL DOOR HOLLOW METAL FRAME HOLLOW METAL DOOR, SOLID CORE WOOD, HOLLOW METAL, SOLID CORE WOOD NOT USED HOLLOW METAL, HALF LITE **ALUMINUM STOREFRONT** SOLID CORE WOOD, [GALVANIZED AT INSULATED VISION LITE HALF LITE DOOR DOUBLE PANEL DOOR DOUBLE PANEL DOOR DOOR EXTERIOR CONDITIONS] DOUBLE PANEL DOOR U = 0.30 MINU = 0.63 MIN $U = 0.63 \, MIN$ G K


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e of Seattle rew Catholic Church Avenue East

Job No: 1851 Date: 2020-02-07 File No: 1851 St. Andrew Parish Hall Drawn By: AMR Checked By: BPC Issued for: PERMIT SET WINDOW AND DOOR TYPES AND SCHEDULES

FLOORING  AF  CONC-1  CONC-2  CONC-3  CPT-1  CPT-2  RS  WOOD  WM	MULTI-USE ACTIVITY FLOORING EPOXY COATED CONCRETE SLAB UNPOLISHED CONCRETE, SEALED STAINED CONCRETE CARPET TILES CARPET TILES RESILIENT SHEET FLOORING PLYWOOD WALK OFF MATTING
BASE RB RS	RUBBER BASE COVE RESILIENT SHEET FLOORING
WALL AC FRP GWB PLAM PNT-1 PNT-2 WD	ACOUSTICAL PANELING FIBERGLASS REINFORCED PANELS GYPSUM WALL BOARD, PAINTED PLASTIC LAMINATE PAINT 1 PAINT 2 WOOD ACCENT WALL
CEILING ACT-1 ACT-2 ACT-3 GWB	ACOUSTIC CEILING TILE CLEANABLE ACOUSTIC CEILING TILI GLUE ON ACOUSTIC TILES GYPSUM WALL BOARD, PAINTED

PAINT 1

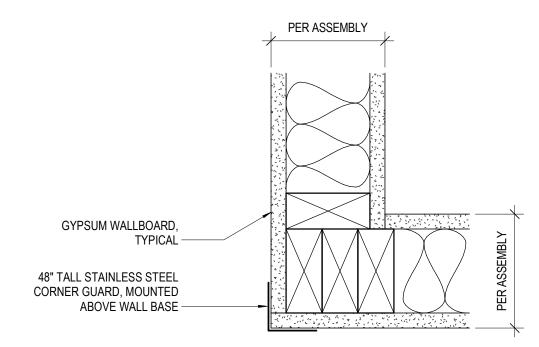

# 2 Typical Corner Protection 3" = 1'-0"

Room Finish Schedule										
		Floor Finish			Wall Finish					
Number	Name	Finish - Floor	Finish - Base	Wall	Finish - East	Finish - North	Finish - South	Finish - West	Ceiling	Comments
01	MECH / STORAGE	CONC-2	6" RB	GWB	PNT-1	PNT-1	PNT-1	PNT-1	GWB	
01					PINI-I	PINI-I	PINI-I	PINI-I		
02	RISER	CONC-2	6" RB	GWB			DNT 4/MED	DNIT 4/N4ED	GWB	
103	JANITOR	RS	COVE RS	GWB/FRP	PNT-1/MFR	PNT-1/MFR	PNT-1/MFR	PNT-1/MFR	GWB	FRP WALL COVER TO EXTEND 60" AFF, INTEGRAL VINYL COVE BASE
	HALLWAY	CONC-3	6" RB	GWB	PNT-1	PNT-1	PNT-1	PNT-1	ACT-1	
05	MEETING 1	CPT-1	4" RB	GWB	PNT-1	PNT-2	PNT-1, *	PNT-1	GWB/ACT-1	MOVEABLE WALL PARTITION TO SOUTH
06	MEETING 2	CPT-1	4" RB	GWB	PNT-1	PNT-1, *	PNT-2	PNT-1	GWB/ACT-1	MOVEABLE WALL PARTITION TO NORTH
07	MEETING 3	CPT-2	4" RB	GWB	PNT-1	PNT-2	PNT-1	PNT-1	GWB/ACT-1	
08	VESTIBULE	WM	6" RB	GWB	PNT-1	PNT-1	PNT-1	PNT-1	GWB	
09	HALLWAY	CONC-3	6" RB	GWB/WD	PNT-1/ST	PNT-1/ST	PNT-1/ST	PNT-1/ST	ACT-1	SEE INTERIOR ELEVATIONS FOR WOOD ACCENT WALL DETAILS
10	VESTIBULE	WM	6" RB	GWB	PNT-1	PNT-1	PNT-1	PNT-1	GWB	
11	WOMEN	RS	COVE RS	GWB/PLAM	PNT-1/MFR	PNT-1/MFR	PNT-1/MFR	PNT-1/MFR	GWB	INTEGRAL VINYL COVE BASE, SEE INTERIOR ELEVATIONS FOR EXTENTS OF PLASTIC LAMINATE WALL COVERING
12	MEN	RS	COVE RS	GWB/PLAM	PNT-1/MFR	PNT-1/MFR	PNT-1/MFR	PNT-1/MFR	GWB	INTEGRAL VINYL COVE BASE, SEE INTERIOR ELEVATIONS FOR EXTENTS OF PLASTIC LAMINATE WALL COVERING
13	HALLWAY	CONC-3	6" RB	GWB	PNT-1	PNT-1	PNT-1	PNT-1	ACT-1	
14	KITCHEN	CONC-1	6" RB	FRP	MFR	MFR	MFR	MFR	ACT-2	
15	STORAGE	CONC-1	6" RB	GWB	PNT-1	PNT-1	PNT-1	PNT-1	ACT-2	
16	STORAGE	CONC-2	6" RB	GWB	PNT-1	PNT-1	PNT-1	PNT-1	GWB	SEE INTERIOR ELEVATIONS FOR PLYWOOD WALL PROTECTION AROUND ROOM PERIMETER
17	HALL	AF	6" RB	GWB/PLAM	PNT-1/MFR	PNT-1/MFR	PNT-1/MFR	PNT-1/MFR	GWB/ACT-3	SEE INTERIOR ELEVATIONS FOR EXTENTS OF ACOUSTICAL WALL COVERING AND PLASTIC LAMINATE WALL COVERING, SEE REFLECTED CEILING PLAN FOR CEILING FINISH LAYOUT
201	MECH	WOOD		GWB	PNT-1	PNT-1	PNT-1	PNT-1	GWB	

#### **ROOM FINISH NOTES**

- 1. PAINT ALL MECHANICAL GRILLS TO MATCH ADJACENT WALL COLOR 2. SEE SPEC FOR ADDITIONAL INFORMATION ON FINISHES AND PAINTS. 3. PAINT ALL GWB CEILINGS PNT-1, UNO. 4. PAINT ALL HM DOORS AND FRAMES PER DOOR SCHEDULE.
  5. AN '\*' IN THE FINISH SCHEDULE REFERS TO SEE NOTES IN COMMENTS
- 6. PROVIDE 48" TALL STAINLESS STEEL CORNER GUARDS PER PLAN LOCATIONS


### **FLOOR FINISH NOTES**

1. SYMBOL / IS TO CLARIFY THE EXTENTS OF MULTIPLE COLORS AND FINISHES. WHERE NOT EXTENTS ARE SNOWN, REFER TO FINISH SCHEDULE. 2. CENTER FLOOR TRANSITIONS UNDER DOORWAYS, TYP. 3. ALL FLOOR TRANSITIONS MUST BE ADA COMPLIANT.



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Archdiocese of Seattle

St. Andrew Catholic Church F
1401 Valley Avenue East
Sumner, WA 98390-2720

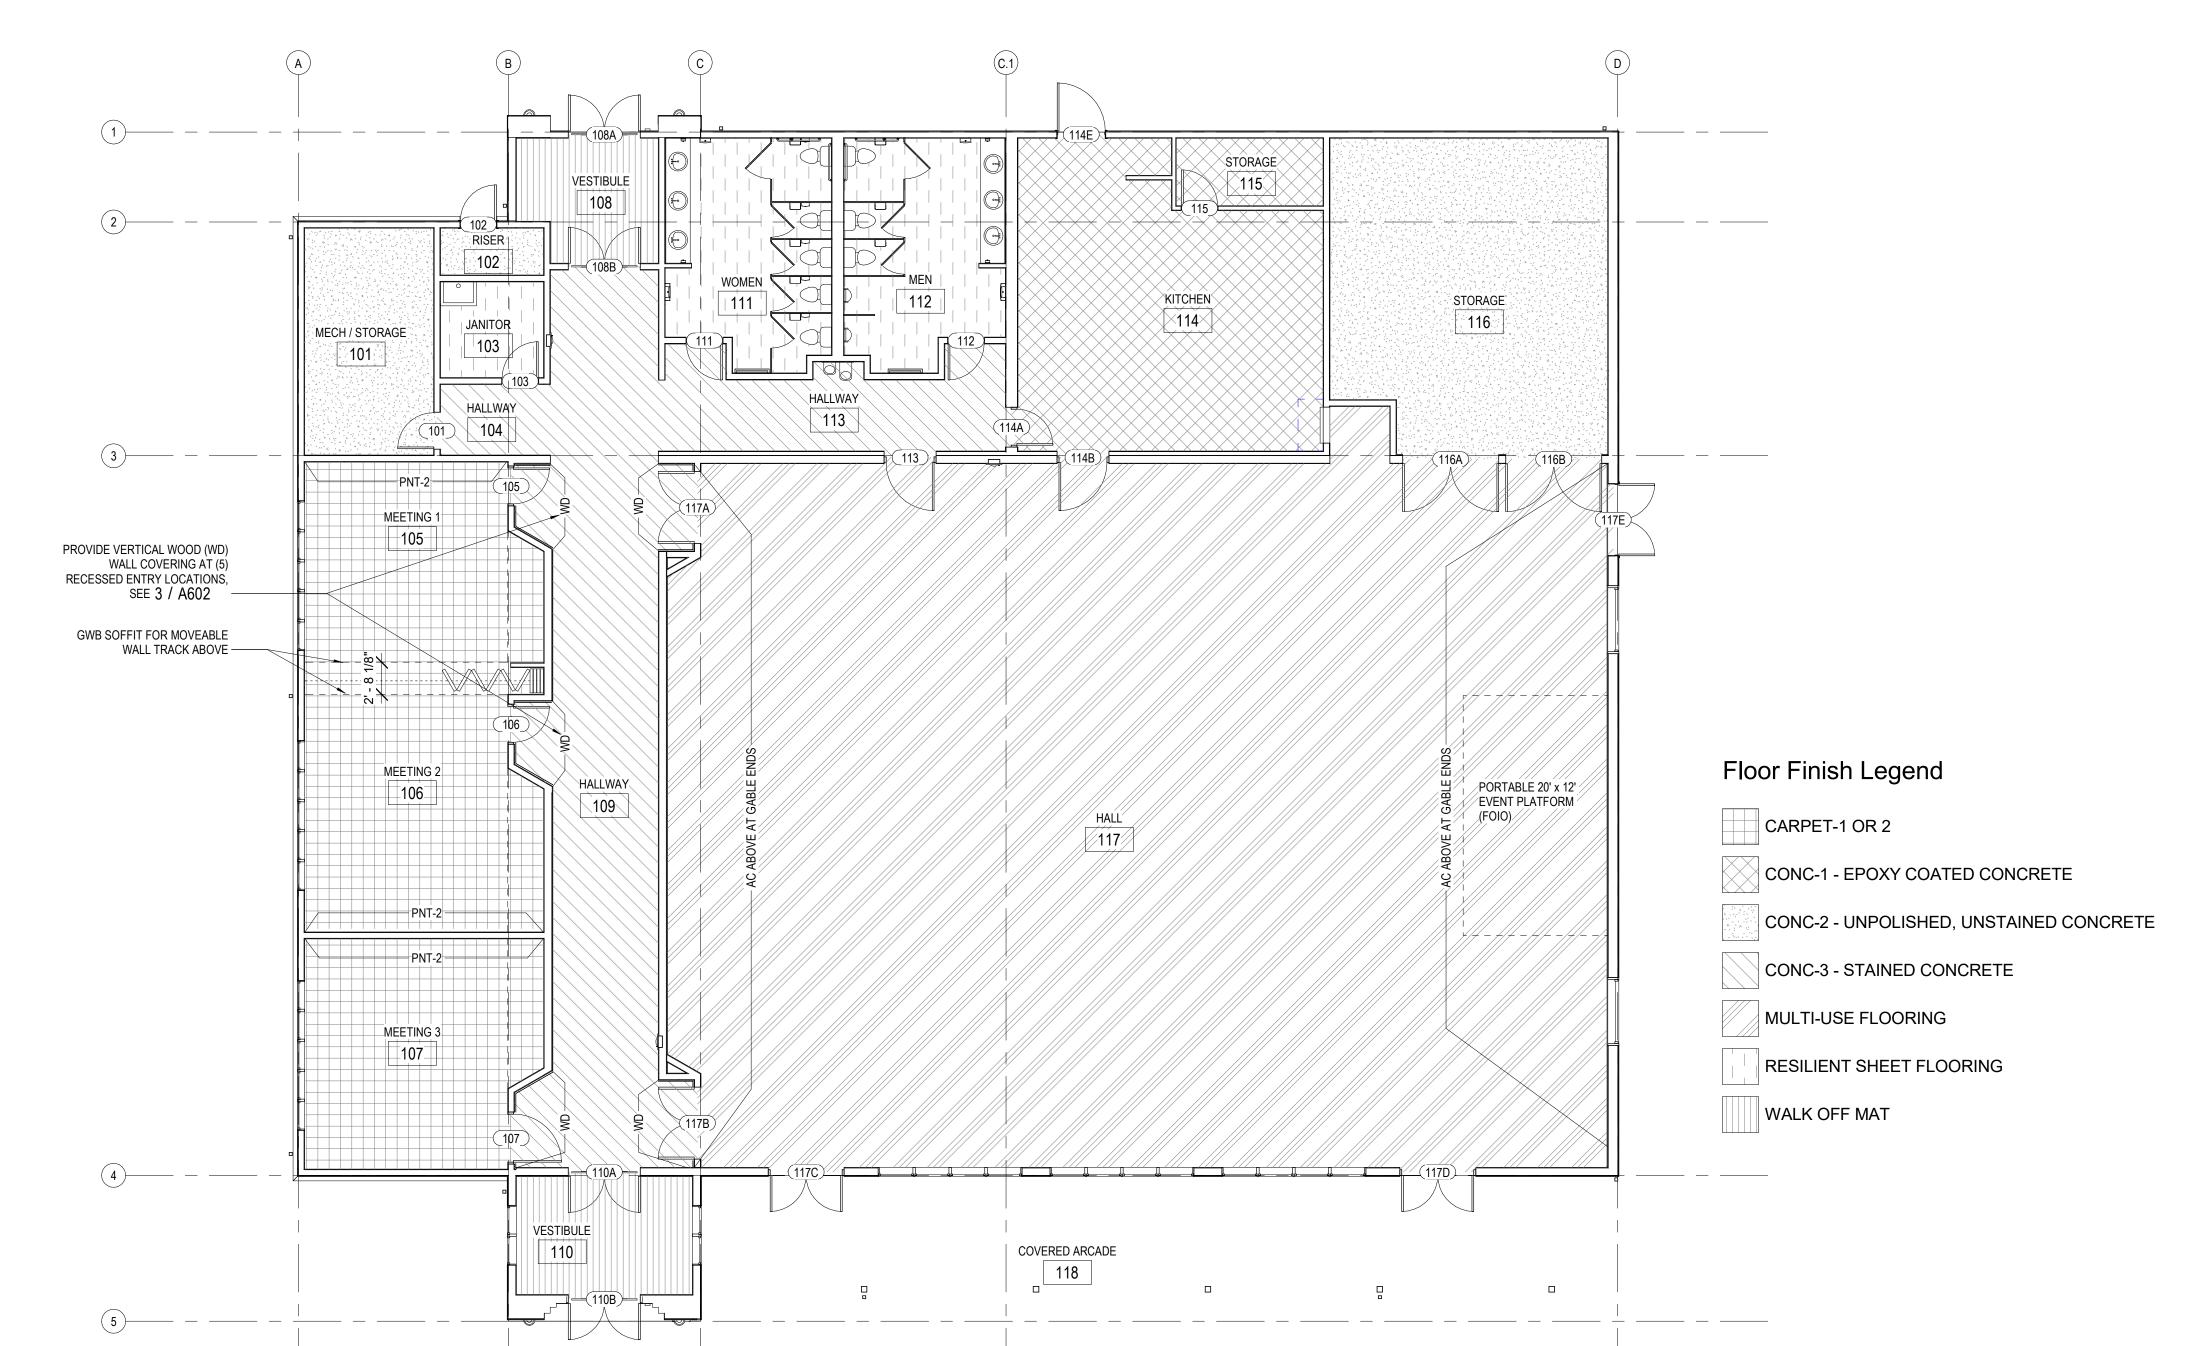Job No:	1851	Date: 2020-02-07
File No:	1851	St. Andrew Parish Hall
Drawn By	y: AMR	<u> </u>
Checked	By: BPC	
Issued fo	r: PER	MIT SET

**ROOM FINISH** PLAN AND SCHEDULE